PROPERTY OWNERS WITHIN 200'

2060 ROUTE 35 - PRESTIGE PLUMBING & HEATING

List of property owners within a 200' radius of Block 422 Lot 8.01(Prestige Plumbing via Himelman): 2067 Route 35, LLC Saulo & Mariana DeAraujo 509 Orchard Place South Amboy, NJ 08879 DKJ Equity, LLC and 2070 Route 35, LLC Brick, NJ 08723

DKJ Equity, LLC and 2070 Route 35, LLC Brick, NJ 08723 2036 Route 35, Inc. East Brunswick, NJ 08816

DKI Equity, LLC and 2070 Route 35, LLC

DKI Equity, LLC and 2070 Route 35, LLC

This is to certify that the preceding list of names, addresses and block and lot numbers are, to the best of my knowledge, within a 200° radius of property known as Block 422 Lot 8.01, as identified on the Official Borough of Sayreville Tax Map.


Be advised that these records may contain information governed by L. 2015, c. 226 and L. 2020, c. 125, which include civil and criminal penalties for improper disclosure.

BOROUGH OF SAYREVILLE MIDDLESEX COUNTY, NEW JERSEY count Tires

KEY MAP SCALE: $1" = 200' \pm$

Broadway Tattoe Lounge 🙋


Tattop shop

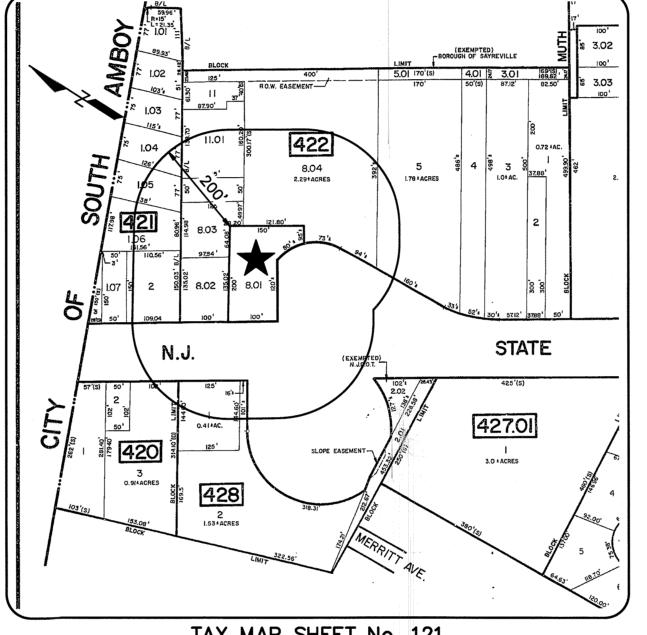

PRELIMINARY & FINAL MAJOR SITE PLAN

BLOCK 422, LOT 8.01

TAX MAP SHEET No. 121 SCALE: $1" = 200' \pm$

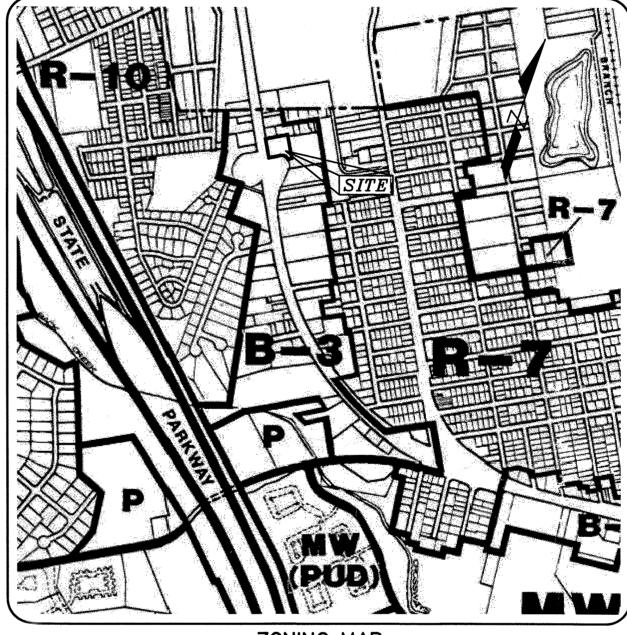

ZONING MAP SCALE: $1" = 1,000' \pm$

GENERAL NOTES

- 1. SITE IS KNOWN AS BLOCK 422, LOT 801 AS DEPICTED ON SHEET 121 OF THE BOROUGH OF SAYREVILLE TAX MAPS. TOTAL LOT AREA IS 20,889 SQ.FT. (0.480

2060 HIGHWAY 35 SOUTH AMBOY, NJ 08879

PRESTIGE PLUMBING & HEATING, INC. 26 JOHNSON STREET STATEN ISLAND, NY 10309 TEL: (917) 886-7249

- 3. OUTBOUND & TOPOGRAPHIC SURVEY INFORMATION OBTAINED FROM A PLAN ENTITLED, "TOPOGRAPHIC SURVEY OF TAX LOT 8.01 IN BLOCK 422, LOCATED IN BOROUGH OF SAYREVILLE, MIDDLESEX COUNTY, NEW JERSEY", PREPARED BY JAMES D. DEADY SURVEYOR, LLC, REVISED DATED JANUARY 5, 2023.
- 4. HORIZONTAL CONTROL BASED ON NJPCS (NAD '83). VERTICAL DATUM BASED ON
- THE SITE IS LOCATED WITHIN FEMA FLOOD HAZARD ZONE X (AREAS OUTSIDE FLOOD HAZARD) AS DEPICTED ON FLOOD INSURANCE RATE MAP COMMUNITY PANEL NUMBER 34023C0159F EFFECTIVE DATE JULY 6, 2010.
- THE PROPERTY IS LOCATED WITHIN THE B-3 "HIGHWAY BUSINESS" ZONE DISTRICT
- 7. THE APPLICANT PROPOSES TO RENOVATE THE EXISTING BUILDING ON THE PROPERTY IN ORDER TO CONSTRUCT A TWO-STORY STRUCTURE WITH A WALK-OUT BASEMENT
- DO NOT SCALE DRAWINGS WITH RESPECT TO THE LOCATION OF SURROUNDING EXISTING FEATURES. ADJACENT AND SURROUNDING PHYSICAL CONDITIONS, BUILDINGS, STRUCTURES, ETC., ARE SCHEMATIC ONLY EXCEPT WHERE DIMENSIONS ARE SHOWN
- THIS SET OF PLANS HAS BEEN PREPARED FOR THE APPLICANT NAMED HEREON FOR THE PURPOSE OF MUNICIPAL AND REGULATORY AGENCY REVIEW AND APPROVAL. THIS SET OF PLANS SHALL NOT BE UTILIZED AS CONSTRUCTION PLANS UNTIL ALL REQUIRED APPROVALS HAVE BEEN OBTAINED. NO OTHER PURPOSE IS INTENDED OR
- 10. REFER TO ARCHITECTURAL DRAWINGS PREPARED BY LAWRENCE MANDARINO. ARCHITECT FOR BUILDING CONSTRUCTION AND DETAILS.
- 11. CONSTRUCTION OF SITE IMPROVEMENTS AND BUILDINGS SHALL BE IN COMPLIANCE WITH THE APPLICABLE BUILDING CODES, FEDERAL AND STATE BARRIER FREE AND A.D.A. REQUIREMENTS, TOWNSHIP DESIGN STANDARDS, AND NOISE CODE.
- 12. THE EXISTING BUILDING IS PRESENTLY CONNECTED TO PUBLIC WATER & INDIVIDUAL SEPTIC DISPOSAL SYSTEM. NO CHANGES ARE NECESSARY TO THE UTILITIES.
- 13. THE CONTRACTOR SHALL NOTIFY THE UNDERSIGNED PROFESSIONAL IMMEDIATELY I SITE CONDITIONS OR TOPOGRAPHY DIFFER MATERIALLY FROM THOSE PRESENTED HEREON. THE UNDERSIGNED PROFESSIONAL SHALL BE GRANTED ACCESS TO REVIEW SAID CONDITION, AND/OR RENDER THE DESIGN SHOWN HEREON TO THE APPROPRIATE MUNICIPAL, COUNTY OR STATE OFFICIAL'S AND/OR UNDERSIGNED PROFESSIONAL SATISFACTION.
- 14. STRUCTURAL / GEOTECHNICAL ENGINEER TO PROVIDE PLANS AND CALCULATIONS FOR ALL STRUCTURES AND FOUNDATIONS AS SHOWN ON THIS PLAN. THIS PLAN DOES NOT INCLUDE BUILDING CALCULATIONS EITHER STRUCTURAL OR GEOTECHNICAL AND THE UNDERSIGNED ASSUMES NO RESPONSIBILITY FOR SAME.
- 15. NO TREE REMOVAL IS PROPOSED
- 16. SOLID WASTE PICKUP SHALL BE BY PRIVATE HAULER.
- 17. SITE LIGHTING SHALL BE CONTROLLED BY A TIMER. SECURITY LIGHTING SHALL BE PROVIDED THROUGH ADDITIONAL MOTION ACTIVATED LIGHT FIXTURES, OR BY DIMMED THE EXISTING LIGHTING TO 50% AFTER HOURS.
- 18. AT COMPLETION OF CONSTRUCTION, AND PRIOR TO THE ISSUANCE OF A PERMANENT CERTIFICATE OF OCCUPANCY, THE GENERAL CONTRACTOR SHALL PREPARE AND SUBMIT AN AS-BUILT SURVEY OF THE PROPERTY TO THE MUNICIPAL ENGINEER FOR

LIST OF UTILITY COMPANIES

LIST OF SAYREVILLE UTILITIES (2024):

36 West State Street P.O. Box 42 Trenton, NJ 08625

Middlesex County Planning Board 75 Bayard Street - 5th Floor New Brunswick, NJ 08902 732-745-3812

David Goldberg Transportation Center 1035 Parkway Avenue P.O. Box 600 Trenton, NJ 08625 **New Jersey Natural Gas Company**

1415 Wyckoff Road Wall Township, NJ 07727 275 Centennial Avenue CN8805

Piscataway, NJ 08855-6805 Attn: Construction Department 732-583-0606 Middlesex County Landfill

East Brunswick, NJ 08816-1636 732-246-4313 Consolidated Rail Corporation 330 Fellowship Road, Suite 300 Mount Laurel, NJ 08054

Verizon New Jersey 540 Broad Street - 20th Floor Newark, NJ 07102 P.O. Box 152206

15 Hoes Lane New Brunswick, NJ 08902 732-721-7000

80 Park Plaza P.O. Box 570 Newark, NJ 07102 JCP&L c/o FirstEnergy 300 Madison Avenue

3751 Bordentown Avenue

P.O. Box 1911 Morristown, NJ 07962-1911 Attn: Corporate Properties 732-723-6609 or 1-800-662-3115 Borough of Sayreville Water & Sewer

Parlin, NJ 08859 Middlesex County Utilities Authority (MCUA) Sayreville, NJ 08872-0086

Transcontinental Gas Pipeline Corporation 315 Cold Soil Road Lawrenceville, NJ 08540 Attn: Robert Ford 1-800-440-8475 P.O. Box 1396 Houston, TX 77251

92 East Main Street, Suite 202 Somerville, NJ 08876 Star Ledger
1 Gateway Center, Suite 1100 Newark, NJ 07102

Home News Tribune

UTILITY NOTES

Used truck of

- 1. EXISTING UTILITY INFORMATION IS BASED ON INFORMATION OF RECORD AND HAS BEEN GATHERED FROM NUMEROUS SOURCES AND IS NOT GUARANTEED AS TO ACCURACY OR COMPLETENESS. THE CONTRACTOR SHALL VERIFY THE LOCATION OF ALL UTILITIES PRIOR TO THE START OF CONSTRUCTION AND REQUEST A MARKOUT BY CONTACTING N.J. ONE-CALL AT (800) 272-1000. IT IS THE CONTRACTOR'S RESPONSIBILITY TO PROTECT ALL EXISTING UTILITIES FROM DAMAGE DURING CONSTRUCTION.
- ALL PROPOSED UTILITIES SHALL BE INSTALLED UNDERGROUND. THE ELECTRIC COMPANY, TELEPHONE & CATV PROVIDERS WILL DETERMINE IF UNDERGROUND SERVICES CAN BE PROVIDED. IF NOT, THEN THOSE UTILITIES SHALL BE OVERHEAD.
- 3. A ROAD OPENING PERMIT MAY BE REQUIRED TO CONNECT CERTAIN UTILITIES TO OFF-SITE FACILITIES. THE CONTRACTOR SHALL OBTAIN THIS PERMIT BY CONTACTING THE MUNICIPAL ROAD DEPARTMENT.
- 4. ALL TRENCHES SHALL BE BACKFILLED WITHOUT DELAY. OPEN TRENCHES SHALL BE KEPT TO A MINIMUM AND PROTECTED AND/OR COVERED WITH STEEL PLATES WHEN WORK IS NOT IN PROGRESS.

DRAWING INDEX

SHEET NO.	DESCRIPTION	DATE	REVISION DATE
1	COVER SHEET	05-16-24	_
2	EXISTING CONDITIONS / DEMOLITION PLAN	05-16-24	_
3	SITE LAYOUT PLAN	05-16-24	_
4	GRADING & UTILITY PLAN	05-16-24	-
5	LANDSCAPING PLAN	05-16-24	_
6	LIGHTING PLAN	05-16-24	_
7	LIGHTING DETAILS	05-16-24	_

B-3 HIGHWAY BUSINESS ZONE DISTRICT REQUIREMENTS

	REQUIRED	EXISTING	PROPOSED	VARIANCE REQ.			
LOT REQUIREMENTS		-					
MINIMUM LOT AREA	20,000 S.F.	20,889 S.F.	20,889 S.F.	NO			
MIN. LOT WIDTH	100 FT	88.2 FT	88.2 FT	*			
MIN. LOT DEPTH	100 FT	200 FT	200 FT	NO			
BUILDING SETBACKS							
FRONT YARD	50 FT	32.2 FT *	40.0 FT	YES			
SIDE YARD	10/20 FT	18.5/47.0 FT	18.0/35.0 FT	NO			
REAR YARD	25 FT	124.7 FT	105.0 FT	NO			
ACCESSORY SHED							
FRONT YARD	N/A	N/A	N/A	NO			
SIDE YARD	10 FT	N/A	N/A	NO			
REAR YARD	25 FT	N/A	N/A	NO			
BLDG. COVERAGE							
MAXIMUM PERMITTED	25%	7.1%	8.2%	NO			
LOT. COVERAGE		(1,600 S.F.)	(1,857 S.F.)				
MAXIMUM PERMITTED	85%	29.3% (6,626 S.F.)	28.4% (6,420 S.F.)	NO			
HEIGHT LIMITATIONS		(0,020 0.1.)	(0,120 0)				
MAX. BLDG. HEIGHT	35 FT	22± FT	28± FT	NO			
	* EXISTING NON-CONFORMITY						

OFF STREET PARKING REQUIREMENTS (CH. 26-88)

USE	REQUIREMENT	SQUARE FOOTAGE PROPOSED	SPACES REQUIRED		
OFFICE AREAS	4 SPACES PER 1,000 S.F.	3,898 S.F.	15.6 SPACES		
STORAGE	1 SPACE PER 5,000 S.F.	242 S.F.	0.05 SPACES		
	TOTAL REQUIRED		16 SPACES		
	TOTAL PROVIDED		10 SPACES *		

* REAR OPEN AREA NOT INCLUDED IN CALCULATION TO BE CONSERVATIVE,

SIGNATURE BLOCKS

APPLICATION NO. _____ APPROVED BY THE BOROUGH OF SAYREVILLE PLANNING BOARD AS A MAJOR SITE PLAN

BOARD CHAIRMAN BOARD SECRETARY

BOARD ENGINEER

			and the first term		
Э.	DATE			DESCRIPTION	
		PRELIMIN	IARY & FIN	IAL MAJOR	SITE PLAN
	2060 R	OUTE 35	- PRESTIG	E PLUMBING	& HEATING, INC.
			SITE LAY	OUT PLA	
		BLOCK 4	22, LOT 8.01	- TAX MAP SHEE	T NO. 121

NEW JERSEY CERTIFICATE OF AUTHORIZATION NO. 24GA28169800


11 South Main Street Marlboro, NJ 07746 Tel: 732.577.0180

MIDDLESEX COUNTY, NEW JERSEY

MARC S. LEBER N.J. PROFESSIONAL ENGINEER, LIGENSE NO. 24GEO4452400 N.J. PROFESSIONAL PLANNER, LIGENSE NO. 33LIOO589800

BOROUGH OF SAYREVILLE


23-345 CHECKED BY: RND SHEET NO. 1 OF 7

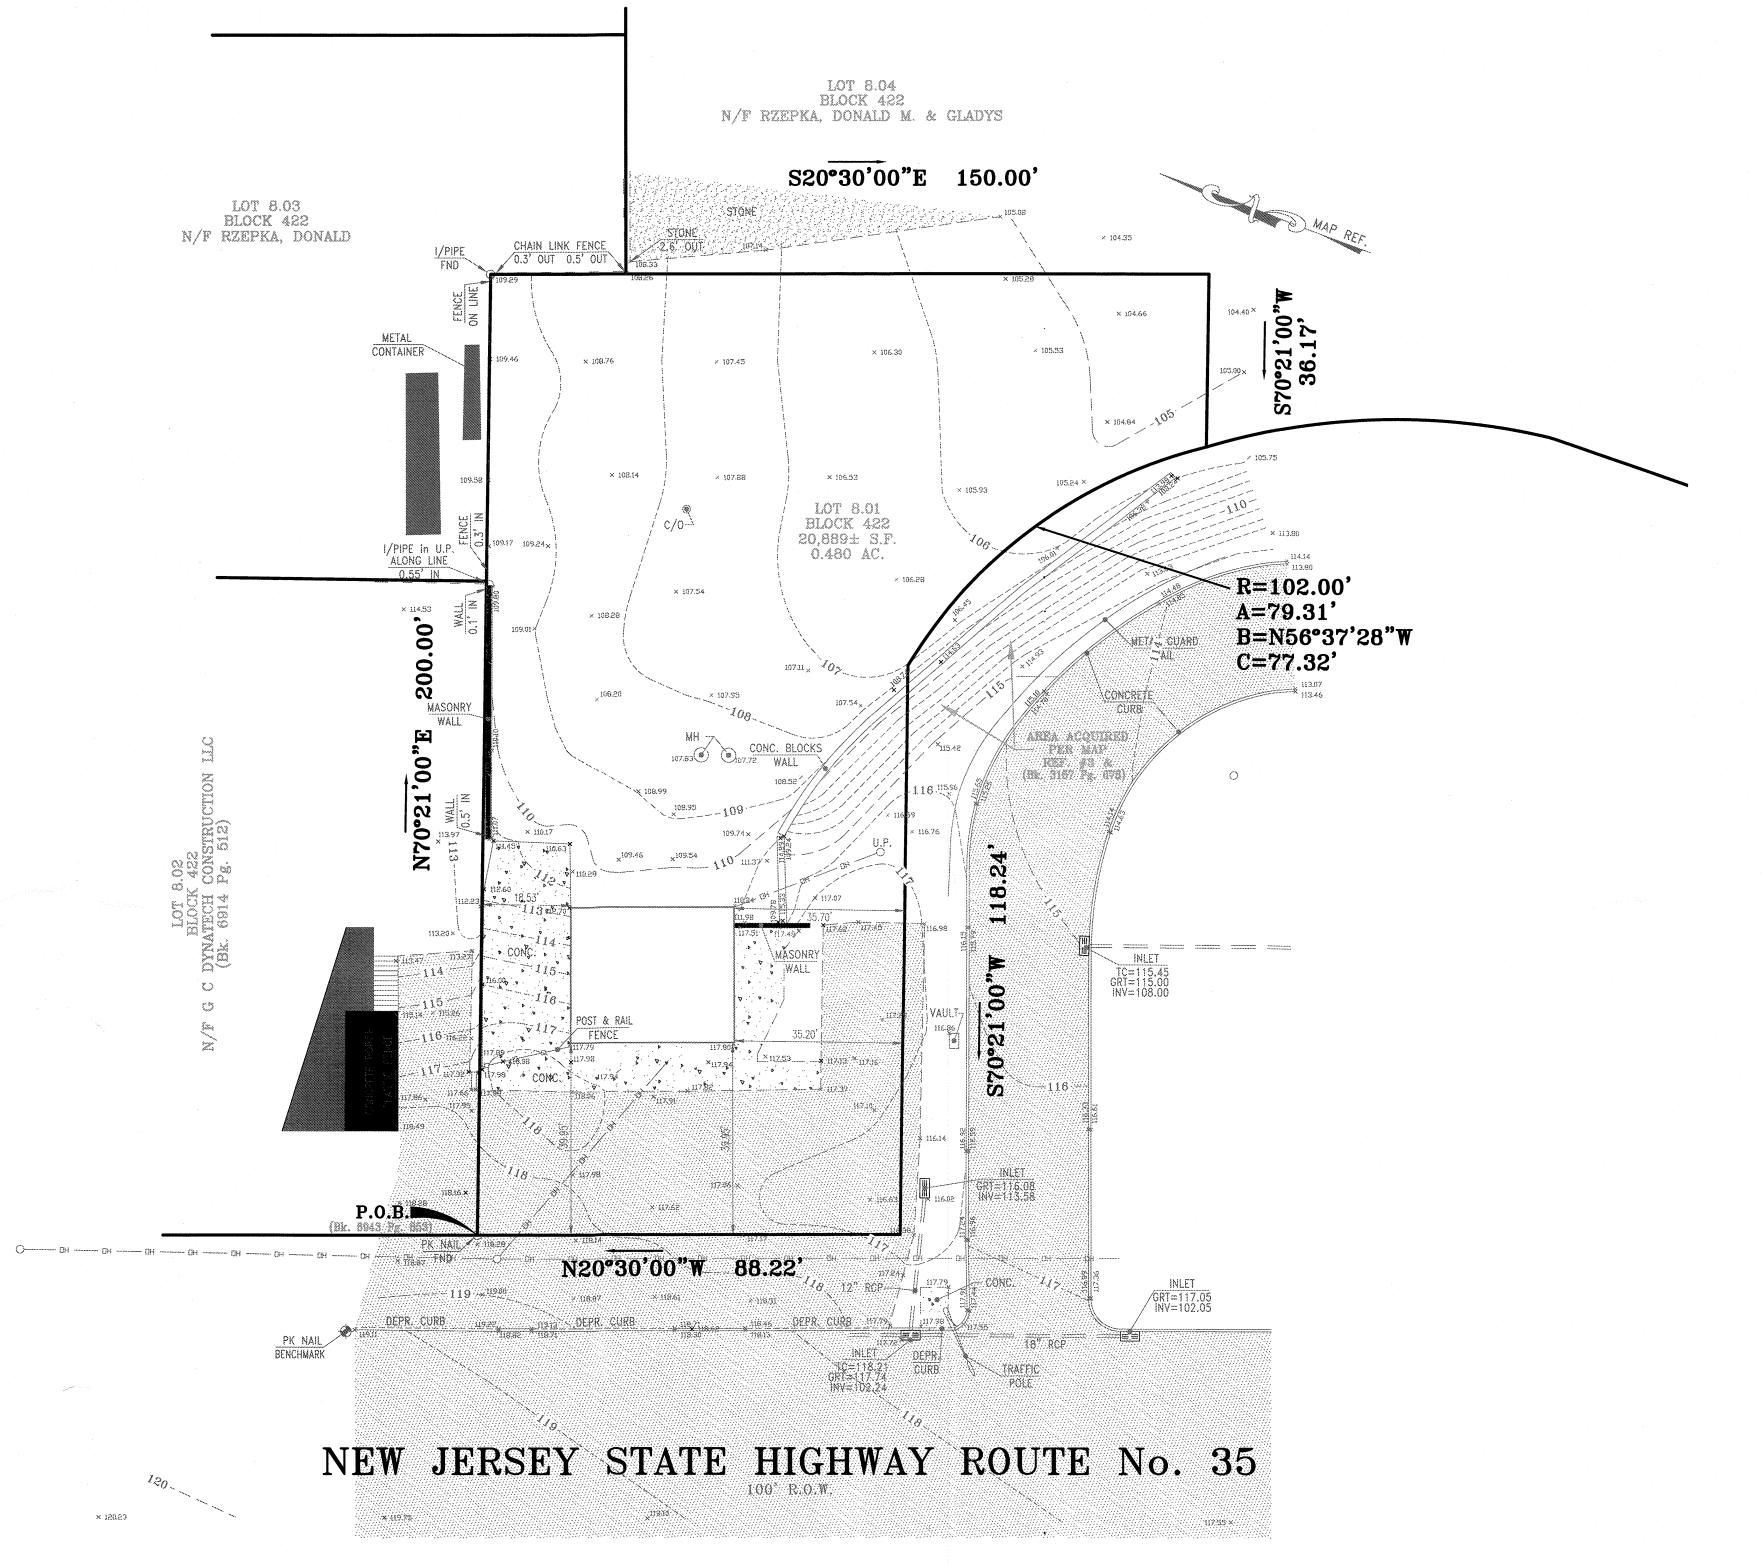

NOTE:

EXISTING BUILDING TO BE RENOVATED / PARTIALLY DEMOLISHED.

ALL OTHER EXISTING IMPROVEMENTS ARE TO REMAIN.

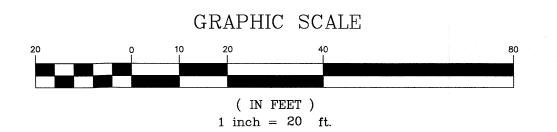

DEMOLITION NOTES

- 1. CLEARING SITE SHALL INCLUDE, BUT IS NOT LIMITED TO, THE REMOVAL OF ALL INDICATED STRUCTURES, FOUNDATIONS, DEBRIS, RUBBLE, FENCES, TREES, STUMPS, EXISTING UTILITIES, UNSUITABLE MATERIALS, PAVEMENT, CONCRETE, AND SIGNAGE.
- 2. THE CONTRACTOR SHALL BE RESPONSIBLE FOR THE DISPOSAL OF ALL MATERIALS EXCAVATED OF WHATEVER NATURE AT HIS OWN EXPENSE. THE MUNICIPALITY IS NOT RESPONSIBLE FOR PROVIDING A DISPOSAL SITE. MATERIALS MUST BE DISPOSED OF IN ACCORDANCE WITH N.J.D.E.P. AND LOCAL REGULATIONS.
- 3. EXISTING ONSITE SUITABLE SOIL SHALL BE EXCAVATED, TRANSPORTED, SPREAD, GRADED, AND COMPACTED AS INDICATED BY THE PROPOSED GRADES. ALL EARTHWORK OPERATIONS INVOLVING ONSITE SOILS SHALL BE COMPLETED PRIOR TO IMPORTING ANY OFFSITE MATERIALS.
- 4. ANY UNSUITABLE MATERIAL FOUND ON SITE DURING DEMOLITION SHALL BE DISPOSED OF OFF-SITE IN ACCORDANCE WITH N.J.D.E.P. AND LOCAL
- 5. NO TOPSOIL IS TO BE REMOVED FROM THE PROJECT SITE.
- 6. PRIOR TO COMMENCING DEMOLITION, THE CONTRACTOR SHALL SECURE THE APPROPRIATE PERMITS FROM THE MUNICIPALITY. IN ORDER TO APPLY FOR A DEMOLITION PERMIT, UTILITY DISCONNECTS MUST BE COORDINATED WITH THE UTILITY COMPANIES INDICATED ON THE COVER SHEET. CONFIRMATION OF THE DISCONNECTS SHALL BE PROVIDED TO THE BUILDING DEPARTMENT.
- 7. IF APPROVED BY THE MUNICIPAL ENGINEER, EXISTING CONCRETE MAY BE STORED ON SITE AND RECYCLED FOR USE AS COMPACTED FILL MATERIAL.
- 8. ALL SOIL EROSION & SEDIMENT CONTROL DEVICES MUST BE IN PLACE AND NOTICE PROVIDED TO THE SOIL CONSERVATION DISTRICT 72 HOURS PRIOR TO COMMENCING WORK.
- 9. A UTILITY MARKOUT MUST BE OBTAINED PRIOR TO DEMOLITION BY CONTACTING NEW JERSEY ONE-CALL AT 800-272-1000.
- 10. THE CONTRACTOR SHALL FAMILIARIZE HIMSELF WITH THE SITE AND THE EXISTING CONDITIONS PRIOR TO BEGINNING CONSTRUCTION. A PRE-CONSTRUCTION MEETING SHALL BE HELD NO LESS THAN 48 HOURS PRIOR TO WORK COMMENCING AND ALL UTILITY COMPANIES SHALL BE NOTIFIED.
- 11. DUMPSTERS USED FOR THE STORAGE OF CONSTRUCTION DEBRIS ARE NOT TO BE LEFT UNCOVERED OVERNIGHT.

SURVEY NOTE:

OUTBOUND & TOPOGRAHIC SURVEY INFORMATION OBTAINED FROM A PLAN ENTITLED, "TOPOGRAPHIC SURVEY OF TAX LOT 8.01 IN BLOCK 422, LOCATED IN BOROUGH OF SAYREVILLE, MIDDLESEX COUNTY, NJ, PREPARED BY JAMES P. DEADY SURVEYOR, LLC, REVISED DATED JANUARY 5, 2023.


PRELIMINARY & FINAL MAJOR SITE PLAN 2060 ROUTE 35 - PRESTIGE PLUMBING & HEATING, INC. SITE LAYOUT PLAN

BLOCK 422, LOT 8.01 - TAX MAP SHEET NO. 121 BOROUGH OF SAYREVILLE MIDDLESEX COUNTY, NEW JERSEY

11 South Main Street Marlboro, NJ 07746 Tel: 732.577.0180

MARC S. LEBER N.J. PROFESSIONAL ENGINEER, LICENSE NO. 24GE04452400 N.J. PROFESSIONAL PLANNER, LICENSE NO. 33LI00589800 SHEET NO. 2 OF 7

NEW JERSEY CERTIFICATE OF AUTHORIZATION NO. 24GAZB169BOO D5-16-24 23-345 CHECKED BY:

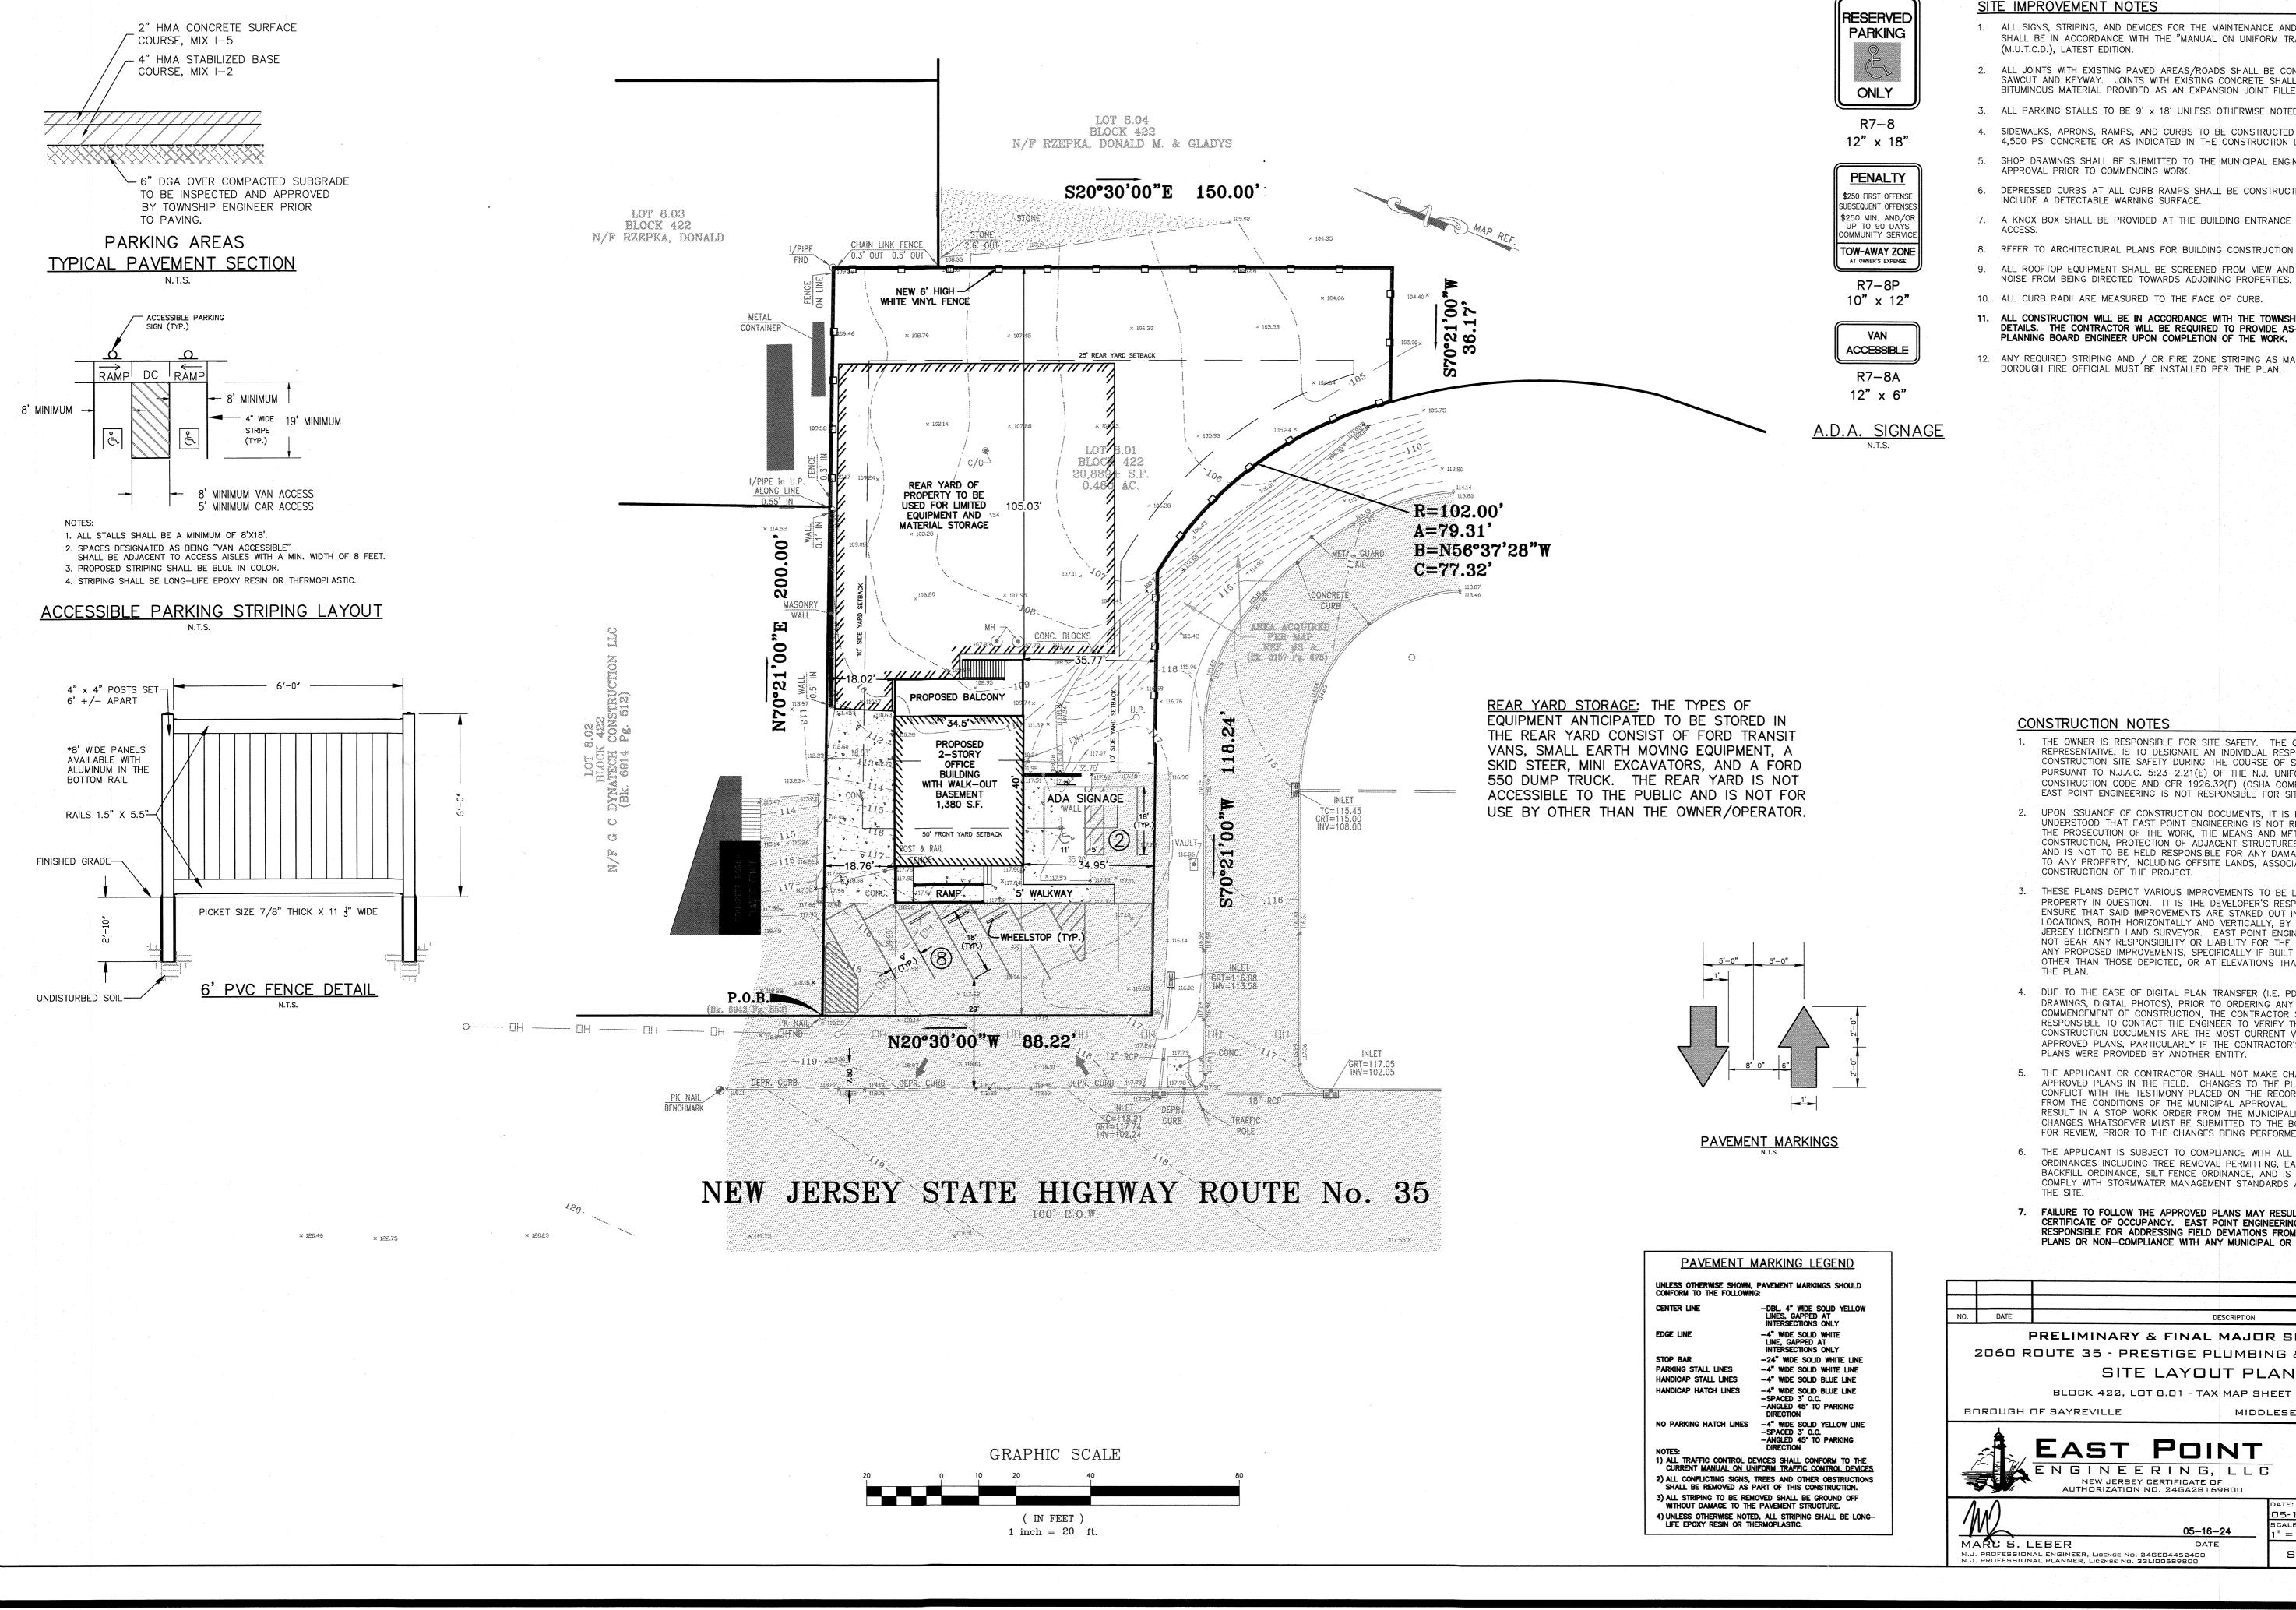

SITE IMPROVEMENT NOTES

- 1. ALL SIGNS, STRIPING, AND DEVICES FOR THE MAINTENANCE AND PROTECTION OF TRAFFIC SHALL BE IN ACCORDANCE WITH THE "MANUAL ON UNIFORM TRAFFIC CONTROL DEVICES" (M.U.T.C.D.), LATEST EDITION.
- 2. ALL JOINTS WITH EXISTING PAVED AREAS/ROADS SHALL BE CONSTRUCTED WITH A NEAT SAWCUT AND KEYWAY. JOINTS WITH EXISTING CONCRETE SHALL BE SAWCUT AND A BITUMINOUS MATERIAL PROVIDED AS AN EXPANSION JOINT FILLER.
- 3. ALL PARKING STALLS TO BE 9' x 18' UNLESS OTHERWISE NOTED ON THE PLANS.
- 4. SIDEWALKS, APRONS, RAMPS, AND CURBS TO BE CONSTRUCTED OF N.J.D.O.T. CLASS 'C', 4,500 PSI CONCRETE OR AS INDICATED IN THE CONSTRUCTION DETAILS.
- 5. SHOP DRAWINGS SHALL BE SUBMITTED TO THE MUNICIPAL ENGINEER FOR REVIEW AND APPROVAL PRIOR TO COMMENCING WORK.
- 6. DEPRESSED CURBS AT ALL CURB RAMPS SHALL BE CONSTRUCTED OUT OF CONCRETE AND
- INCLUDE A DETECTABLE WARNING SURFACE. 7. A KNOX BOX SHALL BE PROVIDED AT THE BUILDING ENTRANCE FOR FIRE DEPARTMENT
- REFER TO ARCHITECTURAL PLANS FOR BUILDING CONSTRUCTION INFORMATION.
- ALL ROOFTOP EQUIPMENT SHALL BE SCREENED FROM VIEW AND THE SCREEN SHALL LIMIT
- 10. ALL CURB RADII ARE MEASURED TO THE FACE OF CURB.
- 11. ALL CONSTRUCTION WILL BE IN ACCORDANCE WITH THE TOWNSHIP DESIGN STANDARDS AND DETAILS. THE CONTRACTOR WILL BE REQUIRED TO PROVIDE AS-BUILT DRAWINGS TO THE PLANNING BOARD ENGINEER UPON COMPLETION OF THE WORK.
- 12. ANY REQUIRED STRIPING AND / OR FIRE ZONE STRIPING AS MAY BE REQUIRED BY THE BOROUGH FIRE OFFICIAL MUST BE INSTALLED PER THE PLAN.

CONSTRUCTION NOTES

- 1. THE OWNER IS RESPONSIBLE FOR SITE SAFETY. THE OWNER, OR HIS REPRESENTATIVE, IS TO DESIGNATE AN INDIVIDUAL RESPONSIBLE FOR CONSTRUCTION SITE SAFETY DURING THE COURSE OF SITE IMPROVEMENTS PURSUANT TO N.J.A.C. 5:23-2.21(E) OF THE N.J. UNIFORM CONSTRUCTION CODE AND CFR 1926.32(F) (OSHA COMPETENT PERSON). EAST POINT ENGINEERING IS NOT RESPONSIBLE FOR SITE SAFETY.
- 2. UPON ISSUANCE OF CONSTRUCTION DOCUMENTS, IT IS EXPLICITLY UNDERSTOOD THAT EAST POINT ENGINEERING IS NOT RESPONSIBLE FOR THE PROSECUTION OF THE WORK, THE MEANS AND METHODS OF CONSTRUCTION, PROTECTION OF ADJACENT STRUCTURES OR PROPERTY AND IS NOT TO BE HELD RESPONSIBLE FOR ANY DAMAGE WHATSOEVER TO ANY PROPERTY, INCLUDING OFFSITE LANDS, ASSOCIATED WITH
- 3. THESE PLANS DEPICT VARIOUS IMPROVEMENTS TO BE LOCATED ON THE PROPERTY IN QUESTION. IT IS THE DEVELOPER'S RESPONSIBILITY TO ENSURE THAT SAID IMPROVEMENTS ARE STAKED OUT IN THE CORRECT LOCATIONS, BOTH HORIZONTALLY AND VERTICALLY, BY RETAINING A NEW JERSEY LICENSED LAND SURVEYOR. EAST POINT ENGINEERING SHALL NOT BEAR ANY RESPONSIBILITY OR LIABILITY FOR THE CONSTRUCTION OF ANY PROPOSED IMPROVEMENTS, SPECIFICALLY IF BUILT IN LOCATIONS OTHER THAN THOSE DEPICTED, OR AT ELEVATIONS THAT DIFFER FROM
- 4. DUE TO THE EASE OF DIGITAL PLAN TRANSFER (I.E. PDF FORMAT DRAWINGS, DIGITAL PHOTOS), PRIOR TO ORDERING ANY MATERIALS OR COMMENCEMENT OF CONSTRUCTION, THE CONTRACTOR SHALL BE RESPONSIBLE TO CONTACT THE ENGINEER TO VERIFY THAT THE CONSTRUCTION DOCUMENTS ARE THE MOST CURRENT VERSION OF THE APPROVED PLANS, PARTICULARLY IF THE CONTRACTOR'S COPY OF THE PLANS WERE PROVIDED BY ANOTHER ENTITY.
- 5. THE APPLICANT OR CONTRACTOR SHALL NOT MAKE CHANGES TO THE APPROVED PLANS IN THE FIELD. CHANGES TO THE PLAN COULD CONFLICT WITH THE TESTIMONY PLACED ON THE RECORD OR DEVIATE FROM THE CONDITIONS OF THE MUNICIPAL APPROVAL. SAME MAY RESULT IN A STOP WORK ORDER FROM THE MUNICIPALITY. ANY CHANGES WHATSOEVER MUST BE SUBMITTED TO THE BOARD ENGINEER FOR REVIEW, PRIOR TO THE CHANGES BEING PERFORMED.
- 6. THE APPLICANT IS SUBJECT TO COMPLIANCE WITH ALL LOCAL MUNICIPAL ORDINANCES INCLUDING TREE REMOVAL PERMITTING, EARTHWORK BACKFILL ORDINANCE, SILT FENCE ORDINANCE, AND IS REQUIRED TO COMPLY WITH STORMWATER MANAGEMENT STANDARDS AS APPROVED FOR
- 7. FAILURE TO FOLLOW THE APPROVED PLANS MAY RESULT IN DENIAL OF A CERTIFICATE OF OCCUPANCY. EAST POINT ENGINEERING IS NOT RESPONSIBLE FOR ADDRESSING FIELD DEVIATIONS FROM THE APPROVED PLANS OR NON-COMPLIANCE WITH ANY MUNICIPAL OR AGENCY OFFICIAL.


PRELIMINARY & FINAL MAJOR SITE PLAN 2060 ROUTE 35 - PRESTIGE PLUMBING & HEATING, INC.


SITE LAYOUT PLAN


BLOCK 422, LOT B.O1 - TAX MAP SHEET NO. 121 MIDDLESEX COUNTY, NEW JERSEY

11 South Main Street Marlboro, NJ 07746 ENGINEERING, LLC Tel: 732.577.0180 NEW JERSEY CERTIFICATE OF AUTHORIZATION NO. 24GA28169800

23-345 05-16-24 CHECKED BY: DATE SHEET NO. 3 OF 7 N.J. PROFESSIONAL ENGINEER, LIGENSE NO. 24GE04452400 N.J. PROFESSIONAL PLANNER, LIGENSE NO. 33LI00589800

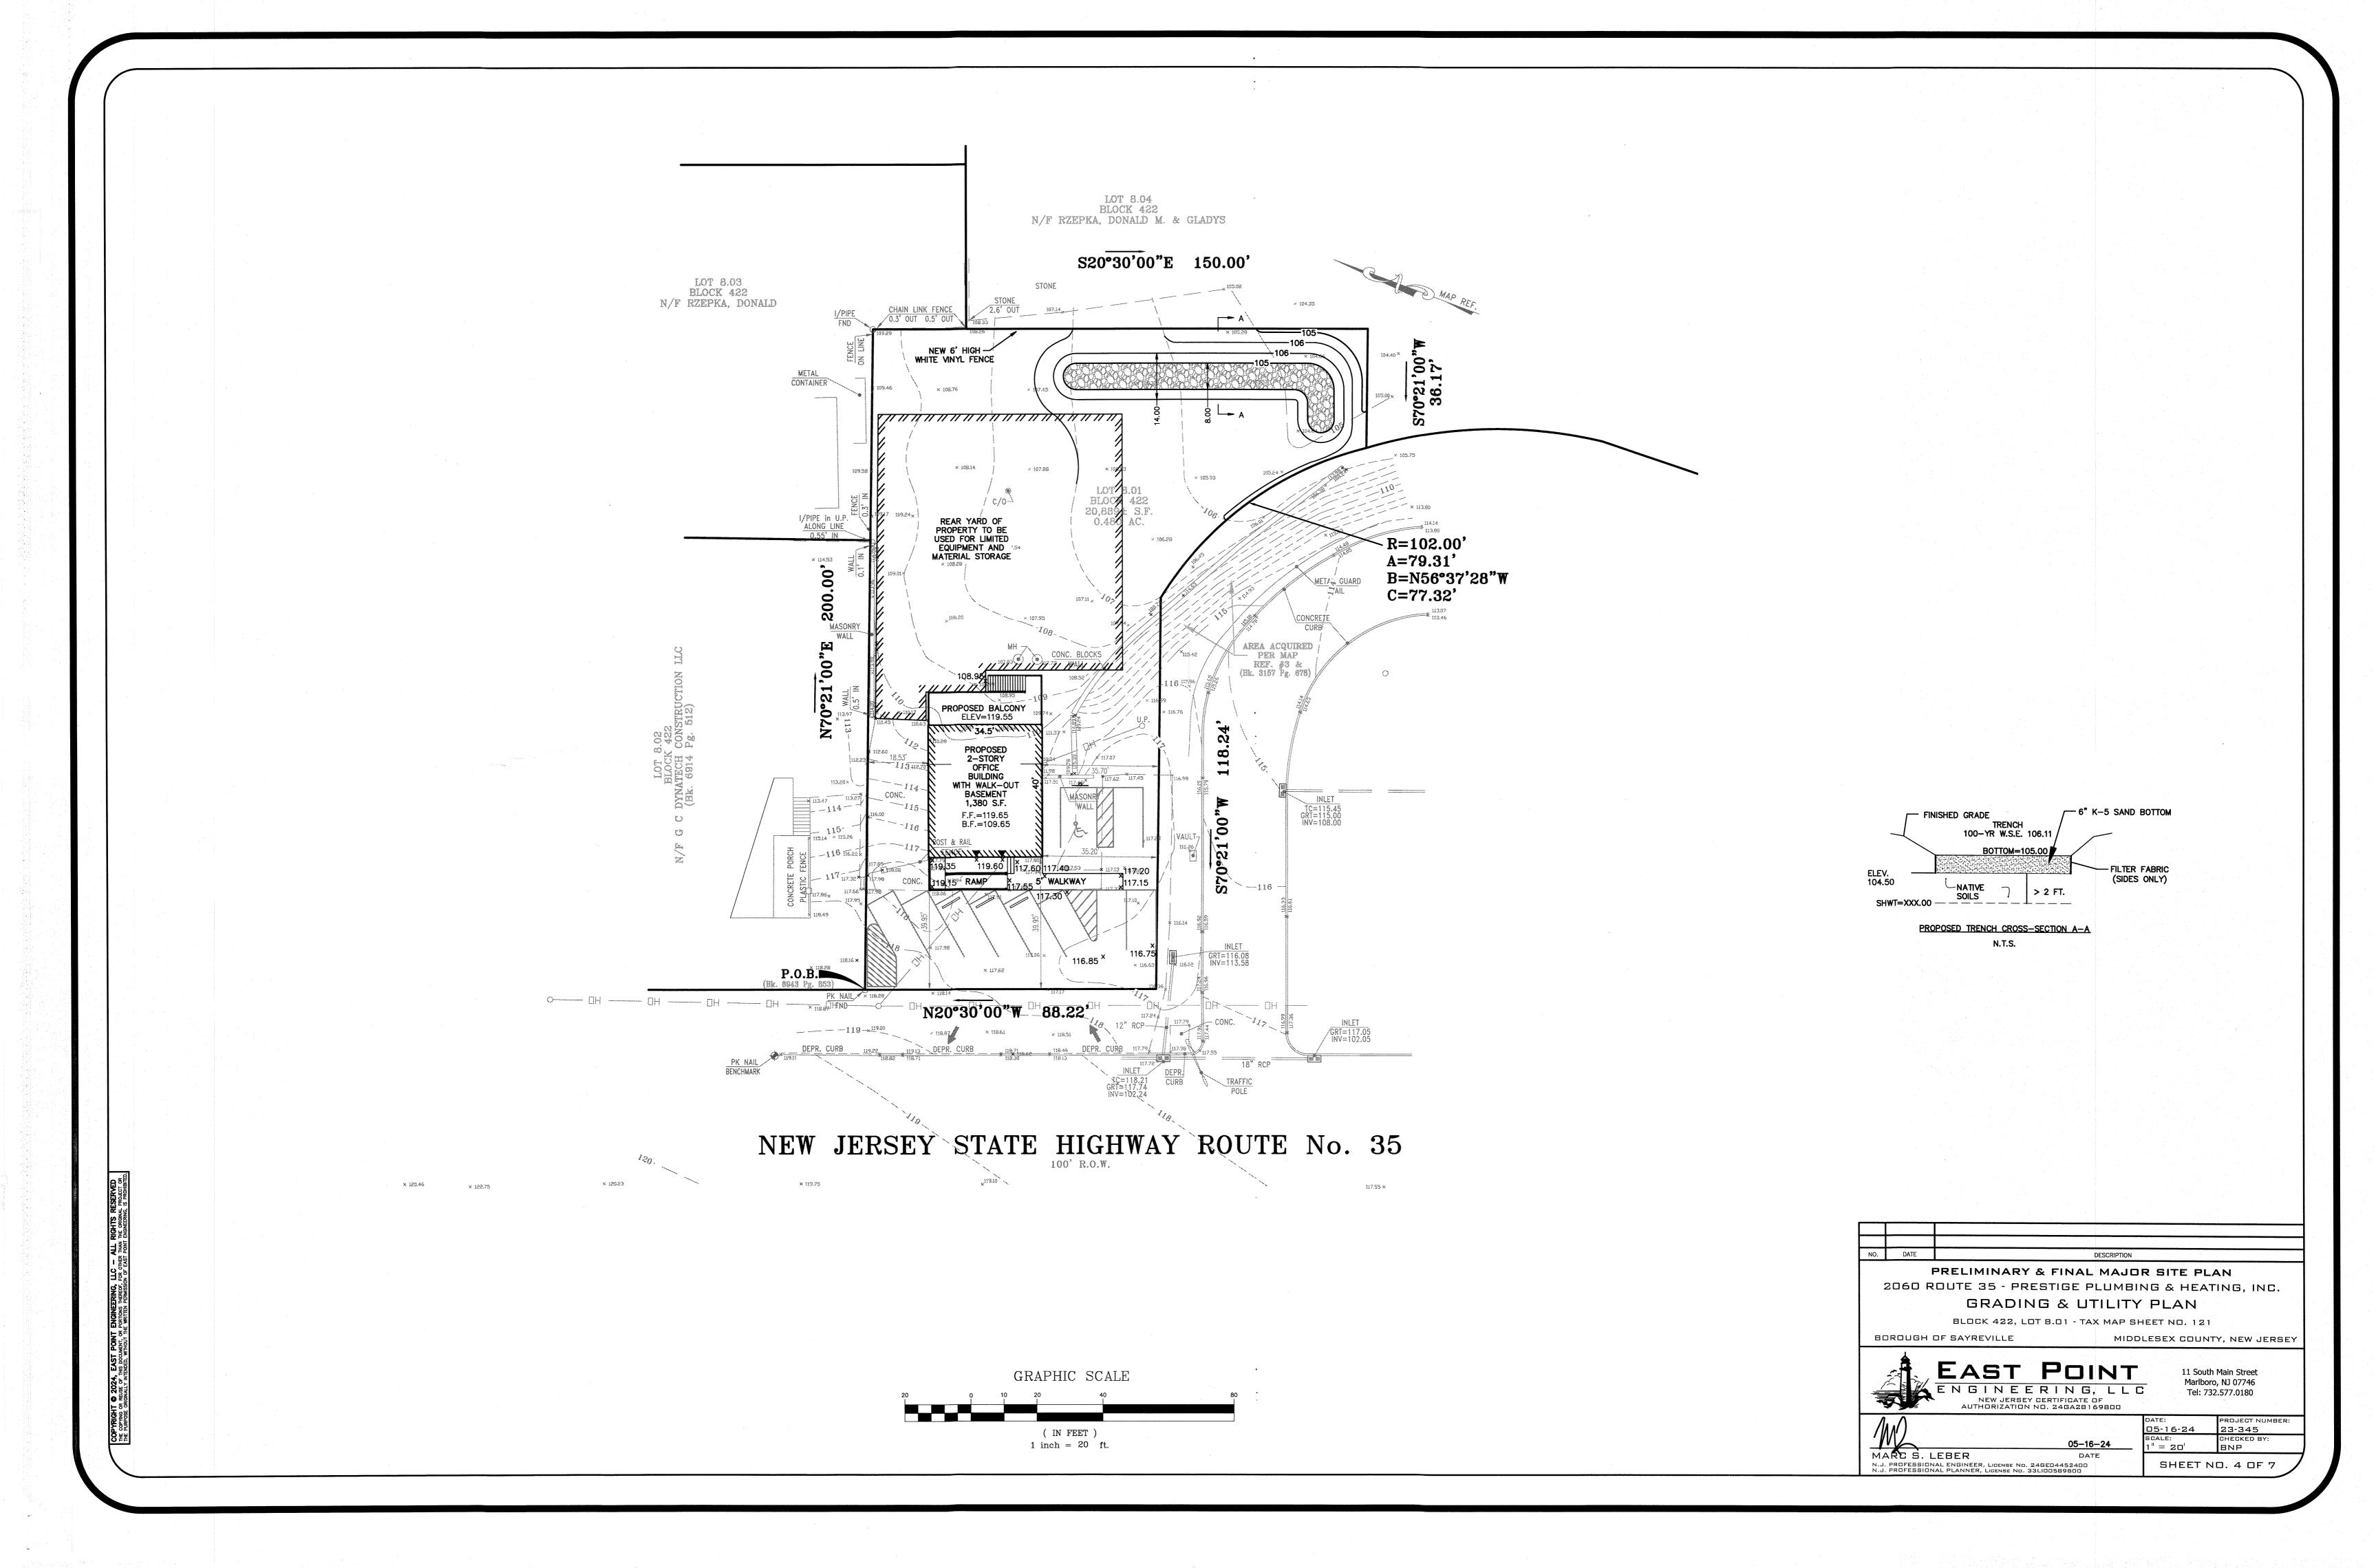

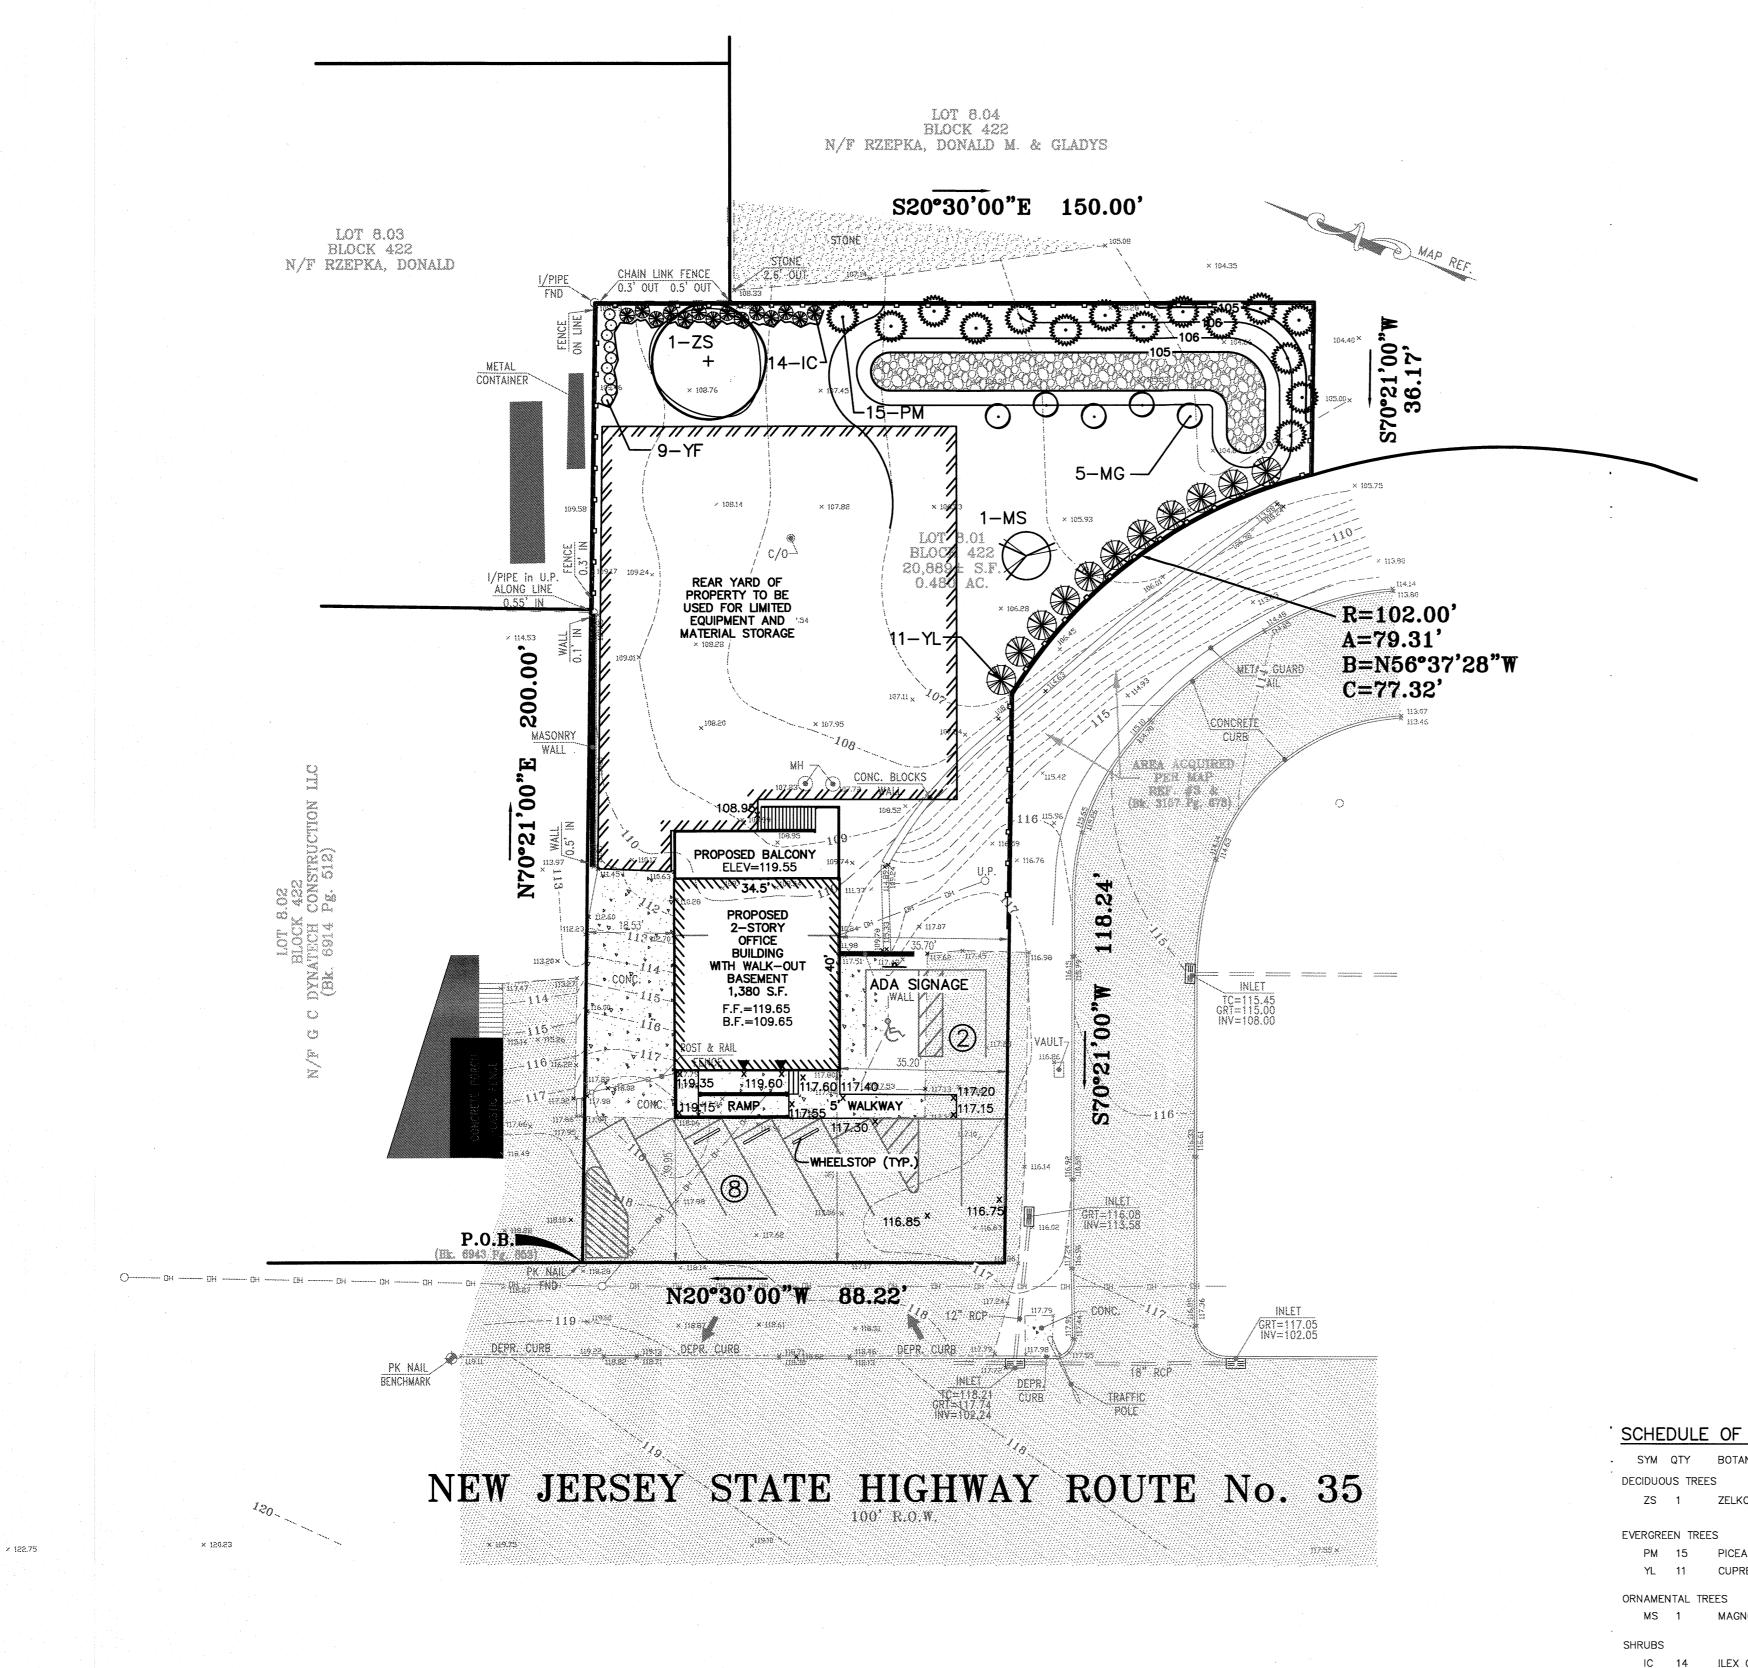

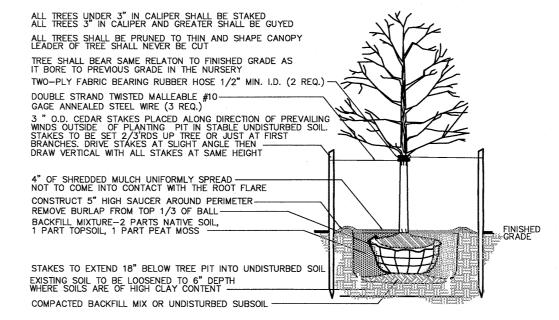

DECIDUOUS TREE PLANTING DETAIL

NOTE: ALL WIRE BASKETS SHALL BE REMOVED FROM THE TREE BALL AFTER SETTLING INTO

THE PLANTING PIT.

PLANTING NOTES: DOUBLE #10 GA. GALVANIZED 1. PLANTING DEPTH SHALL BE THE SAME AS GROWN IN NURSERY. WIRE GUYS TWISTED 2. WIRE BASKETS TO BE REMOVED PRIOR TO BACKFILLING THE PLANTING PIT. 3. THE CENTRAL LEADER SHALL NOT BE CUT OT DAMAGED. REINFORCED RUBBER HOSE (1/2" DIA.) 2" DIA. HARDWOOD STAKES 2/3 TREE HT. - 2 PER TREE TURN BACK BURLAP 1/3 FROM ROOT BALL - 4" SHREDDED HARDWOOD BARK MULCH - SAUCER RIM FINISHED GRADE PREPARED BACKFILL MIX SEE SPECIFICATIONS


CONIFEROUS TREE PLANTING DETAIL

- Undisturbed Subgrade

1. PLANTING DEPTH SHALL BE THE

SAME AS CROWN IN NURSERY.

NOTE: ALL WIRE BASKETS SHALL BE REMOVED FROM THE TREE BALL AFTER SETTLING INTO THE PLANTING PIT.

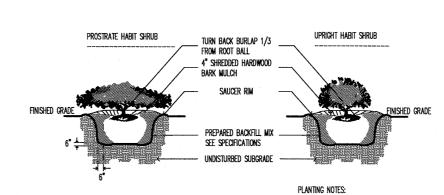

SHRUB PLANTING DETAIL

SCHEDULE OF PLANTING MATERIALS

20HE	DULE	. OF PLANTING MATERIALS)		
. SYM	QTY	BOTANICAL NAME	COMMON NAME	SIZE	REMARKS
DECIDUO	US TREE	ES			
ZS	1	ZELKOVA SERRATA	JAPANESE ZELKOVA	2.5"-3" CAL. 12'-15' HT.	B&B
EVERGRE	EN TRE	ES			
PM	15	PICEA PUNGENS	COLORADO BLUE SPRUCE	5'-6' HT	B&B
YL	11	CUPRESSUS X LEYLANDII	LEYLAND CYPRESS	5'-6' HT	B&B
ORNAME	NTAL TE	REES			
MS	1	MAGNOLIA STELLATA	STAR MAGNOLIA	8'-10' HT	B&B, MULTISTEMMED
SHRUBS					
IC	14	ILEX CRENATA 'HELLERI'	DWARF JAPANESE HOLLY	36" HT	# 3 CAN
YF	9	YUCCA FILAMENTOSA	ADAM'S NEEDLE	15-18" HT	# 3 CAN
ORNAME	NTAL G	RASSES			
MG	5	MISCANTHUS SINENSIS 'GRACILIMUS'	CHINESE MAIDENGRASS	24-36" HT	# 3 CAN

PLANTING NOTES

- 1. THIS PLAN SHALL BE USED FOR LANDSCAPE PLANTING PURPOSES ONLY. EXAMINE ALL ENGINEERING DRAWINGS AND FIELD CONDITIONS FOR SPECIFIC LOCATIONS OF UTILITIES, STRUCTURES, ETC. AND NOTIFY THE UNDERSIGNED IN REFERENCE TO ANY DISCREPENCIES OR LOCATION CONFLICTS PRIOR TO PLANTING INSTALLATION.
- 2. ALL PLANT MATERIAL SHALL CONFORM TO THE STANDARDS OF THE AMERICAN ASSOCIATION OF NURSERYMEN OR THE PLANT MATERIAL WILL BE UNACCEPTABLE. ALL PLANT MATERIAL SHALL BE TRUE TO SPECIES, VARIETY, SIZE AND BE CERTIFIED DISEASE AND INSECT FREE.
- 3. NO PLANT SUBSTITUTIONS SHALL BE PERMITTED WITH REGARDS TO SIZE, SPECIES, VARIETY, ETC. WITHOUT WRITTEN PERMISSION OF THE THE UNDERSIGNED OR TOWNSHIP OFFICIALS. WRITTEN PROOF
- OF PLANT MATERIAL UNAVAILABILITY MUST BE DOCUMENTED.

 4. THE LOCATION OF ALL PLANT MATERIAL INDICATED ON THE LANDSCAPE PLANS IS APPROXIMATE. THE FINAL LOCATION OF ALL PLANT MATERIAL AND PLANTING BED LINES SHALL BE DETERMINED IN THE FIELD UNDER THE DIRECTION OF THE LANDSCAPE ARCHITECT. NO SHADE TREE, STREET TREE, ORNAMENTAL FLOWERING TREE OR EVERGREEN TREE SHALL BE PLANTED CLOSER THAN 5' FROM ANY

SIDEWALK, DRIVEWAY, CURB OR UTILITY LOCATION, OR WITHIN 10' OF A SEPTIC FIELD, UNLESS

SPECIFICALLY DIMENSIONED ON THE LANDSCAPE PLAN.


- 5. ALL STREET TREES AND SHADE TREES PLANTED NEAR PEDESTRIAN OR VEHICULAR ACCESS SHOULD NOT BE BRANCHED LOWER THAN 7'-0" ABOVE GRADE. ALL PLANT MATERIAL LOCATED WITHIN ANY SIGHT TRIANGLE EASEMENTS SHALL NOT EXCEED A MATURE HEIGHT OF 30" ABOVE THE ELEVATION OF THE ADJACENT CURB. ALL STREET TREES PLANTED IN ANY SIGHT TRIANGLE EASEMENTS SHALL BE PRUNED AS MENTIONED ABOVE.
- 6. THE PLANTING PLAN SHALL TAKE PRECEDENCE OVER THE PLANT SCHEDULE SHOULD ANY PLANT QUANTITY DISCREPANCIES OCCUR.
- 7. ALL PLANT MATERIAL SHALL BE PROPERLY GUYED, STAKED, WRAPPED AND PLANTED IN CONFORMANCE WITH THE TYPICAL PLANTING DETAILS. GUY WIRES SHALL BE ATTACHED TO THE TREE AT A HEIGHT OF TWO—THIRDS THE HEIGHT OF THE TREE AND SHOULD BE LOCATED AT POINTS SO NOT TO SPLIT THE TRUNKS OF MULTI—STEMMED TREES. UNLESS OTHERWISE NOTED, PROVIDE THREE TREE STAKES PER TREE. INSTALL ALL PLANT MATERIAL ON UNDISTURBED GRADE. PROVIDE BURLAP WRAPPING WITH A 50% OVERLAP. CUT AND REMOVE BURLAP FROM TOP ONE—THIRD OF THE ROOT BALL.
- 8. PROVIDE PLANTING PITS AS INDICATED ON THE PLANTING DETAILS. BACKFILL PLANTING PITS WITH ONE PART EACH OF TOPSOIL, PEAT MOSS AND PARENT MATERIAL. IF WET SOIL CONDITIONS EXIST THEN PLANTING PITS SHALL BE BE EXCAVATED AN ADDITIONAL 12" AND FILLED WITH SAND.
- 9. ALL PLANT MATERIAL SHALL BEAR THE SAME RELATION TO FINISHED GRADE AS IT BORE TO EXISTING
- 10. NEWLY INSTALLED PLANT MATERIAL SHALL BE WATERED AT THE TIME OF INSTALLATION. REGULAR WATERING SHALL BE PROVIDED TO ENSURE THE ESTABLISHMENT, GROWTH AND SURVIVAL OF ALL
- 11. ALL PLANT MATERIAL SHALL BE GUARANTEED FOR TWO (2) YEARS AFTER THE DATE OF FINAL ACCEPTANCE BY THE MUNICIPALITY.
- 12. THE LANDSCAPE CONTRACTOR SHALL PROVIDE A MINIMUM 4" LAYER OF TOPSOIL IN ALL LAWN AREAS AND A MINIMUM OF 12" OF TOPSOIL IN ALL PLANTING AREAS. A FULL SOIL ANALYSIS SHALL BE CONDUCTED AFTER CONSTRUCTION AND PRIOR TO PLANTING TO DETERMINE THE EXTENT OF SOIL
- 13. ALL DISTURBED LAWN AREAS SHALL BE STABILIZED WITH EITHER SOD OR SEED AS INDICATED ON THE LANDSCAPE PLANS. SOD SHALL CONSIST OF A NEW JERSEY CERTIFIED MIXTURE OR AN APPROVED EQUAL. SEED MIXTURE SHALL BE AS LISTED IN THE SEEDING SCHEDULE. ALL DISTURBED LAWN AREAS SHALL BE TOPSOILED, LIMED, FERTILIZED AND FINE GRADED PRIOR TO LAWN INSTALLATION.
- 14. ALL PLANTING BEDS SHALL RECEIVE LANDCAPE ROCK OR RIVER STONE. THE USE OF SHREDDED HARDWOOD BARK OR MULCH IS PROHIBITED.
- 15. ALL EXISTING TREES AND SHRUBS TO BE PRESERVED ON SITE SHALL BE PROTECTED AGAINST CONSTRUCTION DAMAGE BY SNOW FENCING. ALL FENCING SHALL BE PLACED OUTSIDE THE INDIVIDUAL TREE CANOPY. ALL TREES TO REMAIN SHALL BE IDENTIFIED IN THE FIELD PRIOR TO COMMENCEMENT OF CONSTRUCTION, GRADING OR CLEARING. ALL EXISTING VEGETATION BEING PRESERVED AND LOCATED AT THE EDGE OF THE NEW TREELINE SHALL BE PRUNED AND TRIMMED TO REMOVE ALL
- DEAD, DISEASED, OR DAMAGED BRANCHES.

 16. AN IRRIGATION SYSTEM IS NOT PROPOSED.

AMENDMENT REQUIRED.

- 17. SHADE & STREET TREES SHOULD BE A MINIMUM OF 2.5"-3" CALIPER AND 12'-15' IN HEIGHT.
- 18. ORNAMENTAL TREES SHOULD BE 8' TO 10' IN HEIGHT.
- 19. SHRUBS SHOULD BE 18" IN HEIGHT UNLESS OTHERWISE NOTED IN THE SCHEDULE.
- 20. ANY NON-BIODEGRADABLE MATERIALS SHALL BE REMOVED FROM THE ROOTBALLS AT THE TIME OF
- 21. GUY WIRES AND STAKES WILL ONLY BE UTILILIZED IF CONDITIONS MERIT. IF UTILIZED, SHOULD BE REMOVED BY THE DEVELOPER AT THE END OF THE GROWTH PERIOD.
- 22. THE CENTRAL LEADER SHOULD NOT BE CUT OR REMOVED FROM THE DECIDUOUS TREES.
- 23. ALL SHRUB AND TREE PLANTING SHALL BE PERFORMED IN ACCORDANCE WITH THE AMERICAN
- STANDARD FOR NURSERY STOCK ANSI Z60.1-2004.

 24. LANDSCAPING SHALL HAVE A TWO (2) YEAR GUARANTEE.
- 25. ROCKS SHALL NOT BE PLACED WITHIN 6" OF THE ROOT COLLAR. THE MINIMUM DIAMETER OF THE SCARIFIED SUB-GRADE SHALL BE 5 TIMES THE ROOT BALL DIAMETER. ALL TWINE, WIRE, ROPE AND BURLAP FROM THE TOP \(\frac{2}{3} \) OF THE ROOT BALL SHALL BE REMOVED.
- 26. MYCOR TREE SAVER SHALL BE MIXED IN THE BACKFILL WHEN PLANTING TREES AND SHRUBS. IN ADDITION, HEALTHY START MACRO TABS 12-8-8 SHALL BE PLACED IN THE UPPER 4" OF THE BACKFILL AROUND TREES AND SHRUBS. THE CONTRACTOR SHALL FOLLOW THE MANUFACTURER'S INSTRUCTIONS FOR USE WITH THESE PRODUCTS.
- 27. ALL LAWN AREAS SHALL RECEIVE A MINIMUM OF 4 INCHES OF TOPSOIL.
- 28. VEGETATIVE COVER SHALL BE IN ACCORDANCE WITH THE STANDARDS FOR SOIL EROSION & SEDIMENT CONTROL IN NEW JERSEY AND APPROVED BY THE FREEHOLD SOIL CONSERVATION DISTRICT.
- 29. ALL AREAS WHERE NATURAL VEGETATION AND/OR SPECIMEN TREES ARE TO REMAIN SHALL BE PROTECTED BY THE ERECTION OF FENCING, AND NO DISTURBANCE SHALL OCCUR PRIOR TO INSPECTION BY THE TOWNSHIP ENGINEER AND THE ISSUANCE OF WRITTEN AUTHORIZATION TO PROCEED WITH CONSTRUCTION. THESE PROTECTIVE MEASURES SHALL NOT BE ALTERED OR REMOVED WITHOUT THE PROPER APPROVAL OF THE TOWNSHIP ENGINEER.
- 30. TOPSOIL IN LANDSCAPE AREAS SHALL HAVE A MINIMUM DEPTH OF TWO (2) FEET FOR SHRUBBERY AND FOUR (4) FEET FOR TREES.
- 31. FOUR SEASON FOUNDATION PLANTINGS SHALL BE PROVIDED, AND ACCENTED WITH SHRUBS, PERENNIALS, AND ORNAMENTAL GRASSES.

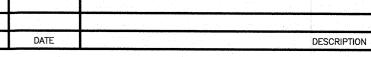

PRELIMINARY & FINAL MAJOR SITE PLAN
2060 ROUTE 35 - PRESTIGE PLUMBING & HEATING, INC.

LANDSCAPING PLAN

BLOCK 422, LOT 8.01 - TAX MAP SHEET NO. 121

BOROUGH OF SAYREVILLE MIDDLESEX COUNTY, NEW JERSEY

EAST POINT

ENGINEERING, LLC

NEW JERSEY CERTIFICATE OF
AUTHORIZATION NO. 24GA28169800

11 South Main Street Marlboro, NJ 07746 Tel: 732.577.0180

MARC S. LEBER

N.J. PROFESSIONAL ENGINEER, LIGENSE NO. 24GED4452400

N.J. PROFESSIONAL PLANNER, LIGENSE NO. 33LI00589800

DATE

DATE:

D5-16-24


23-345


SCALE:

1" = 20'

BNP

SHEET NO. 5 OF 7

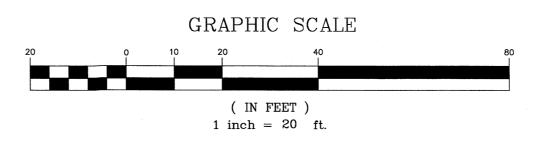

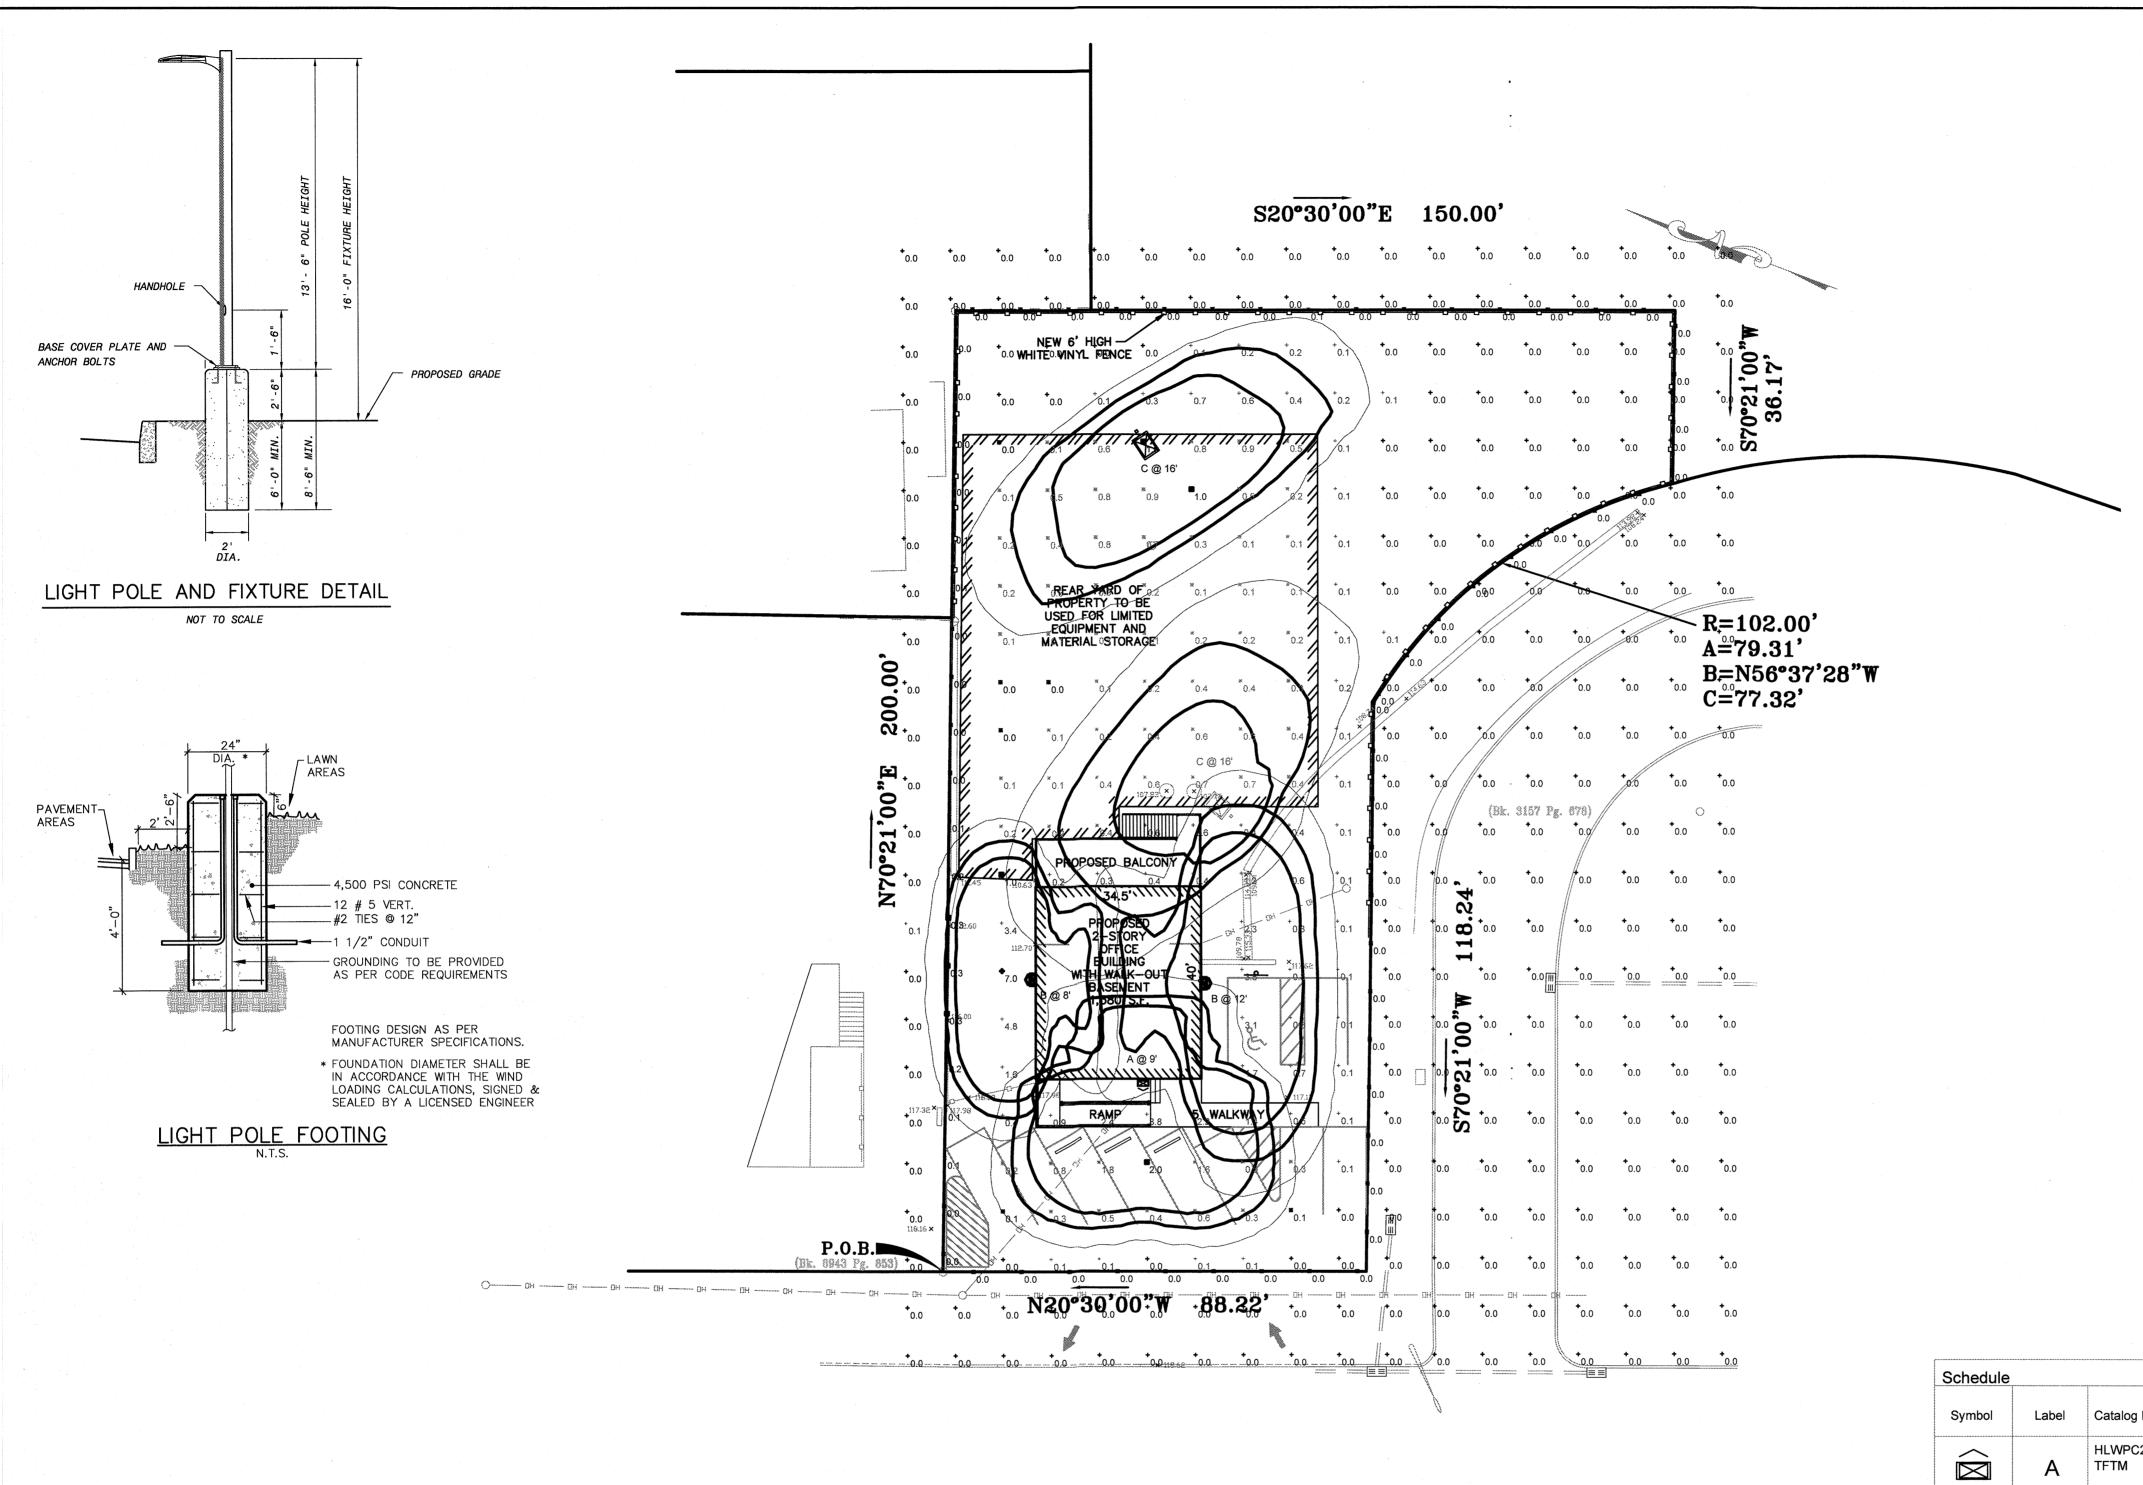

LIGHTING NOTES

- 1. SITE LIGHTING LAYOUT AND DESIGN IS DEPICTED ON THE LIGHTING PLAN.
- 2. ALL SITE LIGHTING SHALL RECEIVE UNDERGROUND ELECTRICAL SERVICE.
- 3. A TIME CLOCK TO CONTROL THE SITE LIGHTING SHALL BE PROVIDED FOR ALL SITE LIGHTING. THE NECESSARY CONTROLS AND WIRING SHALL BE PROVIDED BY THE ELECTRICAL CONTRACTOR.
- 4. HOURS OF THE PROPOSED SITE LIGHTING SHALL BE ONE-HALF HOUR BEFORE SUNSET TO ONE-HALF HOUR AFTER SUNRISE. LIGHTING MAY BE WIRED IN SECTIONS WITH SOME SECTIONS TURNING OFF AFTER MIDNIGHT TO CONSERVE ENERGY. ESSENTIAL SECTIONS DESIGNATED SECURITY LIGHTING SHALL NOT TURN OFF UNTIL ONE-HALF HOUR AFTER SUNRISE.
- 5. THE ELECTRICAL CONTRACTOR SHALL PROVIDE POLE FOUNDATIONS COMPLETE WITH CONDUITS FOR POWER, GROUNDING, AND ANCHOR BOLTS.
- 6. ALL POLES THAT ARE NOT BEHIND CURBS OR WITHIN A CURBED ISLAND SHALL BE INSTALLED ON CONCRETE BASES THAT EXTEND 30" ABOVE THE FINISHED GRADE OF PAVEMENT. THE SITE CONTRACTOR SHALL BE RESPONSIBLE TO PROVIDE THE COMPLETE DESIGN OF THESE BASES AS SIGNED AND SEALED BY A NEW JERSEY LICENSED ENGINEER.
- 7. THE ELECTRICAL CONTRACTOR SHALL BE RESPONSIBLE FOR INSTALLING ALL LIGHTING FIXTURES, POLES, FOUNDATIONS, AND LAMPS.
- 8. THE ELECTRICAL CONTRACTOR SHALL FURNISH AND INSTALL THE REQUIRED BRANCH CIRCUIT WIRING AND CONNECT THE SITE LIGHTING FIXTURES TO THE PROPER CIRCUITS AFTER THEY HAVE BEEN INSTALLED.
- 9. THE ELECTRICAL CONTRACTOR SHALL PROVIDE GROUND RODS AND MAKE CONNECTION TO THE GROUND STUD. THE GROUND STUD SHOULD BE LOCATED INSIDE THE SHAFT AND ACCESSIBLE VIA A HANDHOLE.
- 10. THE ELECTRICAL CONTRACTOR MUST COORDINATE THE INSTALLATION OF WIRING IN THE POLES UP TO THE LIGHTING FIXTURES.
- 11. THE NUMBER AND SIZE OF THE POWER CONDUITS SHALL BE PROVIDED BY THE ELECTRICAL CONTRACTOR.
- 12. ALL SITE LIGHTING SHALL CONFORM TO THE REQUIREMENTS OF THE
- MUNICIPALITY, THE ELECTRIC UTILITY, AND THE RECOMMENDATIONS OF THE ILLUMINATING ENGINEERING SOCIETY OF NORTH AMERICA (IESNA).
- 13. SITE LIGHTING SPECIFIED SHALL BE INSTALLED PER MANUFACTURER'S DETAILS AND SPECIFICATIONS.
- 14. POLES AND LUMINAIRES SHALL BE INSTALLED PER MANUFACTURER'S
- 15. ALL CONDUIT SHALL BE 2" DIAMETER, SCHEDULE 40 P.V.C. WITH A MINIMUM
- 16. ALL SWEEPS SHALL HAVE A MINIMUM RADIUS OF 24". NO ELBOWS SHALL BE PERMITTED.

Light Lo	evel Illuminance Statistics	Avg Max Min Max/Min 0.0 fc 0.3 fc 0.0 fc N/A 0.2 fc 7.0 fc 0.0 fc N/A 0.7 fc 2.0 fc 0.1 fc 20.0:1				
Symbol	Description	Avg	Max	Min	Max/Min	Avg/Min
Ж	PROPERTY LINE	0.0 fc	0.3 fc	0.0 fc	N/A	N/A
+	SITE CALCULATIONS	0.2 fc	7.0 fc	0.0 fc	N/A	N/A
Ж	PARKING SPACES	0.7 fc	2.0 fc	0.1 fc	20.0:1	7.0:1
Ж	REAR YARD CALCULATIONS	0.4 fc	1.0 fc	0.0 fc	N/A	N/A

Schedule	***************************************		,,,,,,,,,,,,,,,,,,,,,,,,,,,,,,,,,,,,,,						
Symbol	Label	Catalog Number	QTY	Description		Number Lamps	Lumens per Lamp	LLF	Wattage
$\widehat{\boxtimes}$	Α	HLWPC2 P10 40K XX TFTM	1		off LED, LED Performance 0 series CCT, Voltage, edium	1	3209	0.9	28
â	В	HLWPC2 P10 40K XX T2S	2		off LED, LED Performance 00 series CCT, Voltage,	1	3128	0.9	28
	С	ACC P151 R4 4K XXX HS	2		mance package Roadway n 4000K CCT House Side	1	1633	0.9	15.4

GRAPHIC SCALE (IN FEET) 1 inch = 20 ft.

PRELIMINARY & FINAL MAJOR SITE PLAN 2060 ROUTE 35 - PRESTIGE PLUMBING & HEATING, INC. LIGHTING PLAN

BLOCK 422, LOT 8.01 - TAX MAP SHEET NO. 121 BOROUGH OF SAYREVILLE MIDDLESEX COUNTY, NEW JERSEY


11 South Main Street Marlboro, NJ 07746 ENGINEERING, LLC

NEW JERSEY CERTIFICATE OF
AUTHORIZATION NO. 24GA28169800 Tel: 732.577.0180


D5-16-24 23-345 CHECKED BY: 05-16-24 MARC S. LEBER DATE SHEET NO. 6 OF 7 N.J. PROFESSIONAL ENGINEER, LICENSE NO. 24GE04452400 N.J. PROFESSIONAL PLANNER, LICENSE NO. 33LI00589800

AutoConnect Series ACC **Roadway Lighting**

PRODUCT OVERVIEW

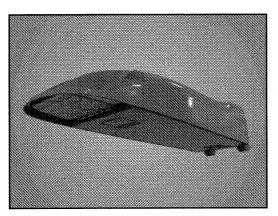

Applications: Off ramps Residential streets Parking lots

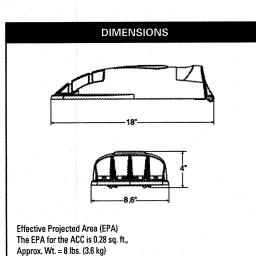

Rated for -40°C to 40°C ambient CSA Certified to U.S. and Canadian standards Complies with ANSI: C136.2, C136.10, C136.31, C136.15, C136.37

Features:

AutoConnect utilizes the most advanced optical technology. Durable, precision optical control is obtained with new silicone materials that permit superior mold detail and denser LED population for Silicone optics are superior to other polymeric materials in the areas of: optical efficiency, thermal performance, and reduction in dirt accumulation, all of which can lead to long term lumen degradation and a shift in optical distribution. Also, because silicone allows for the molding of details as well as thick sections, it produces the most crisp, clean and well-defined lighting Silicone optics paired with modern LED's allow the AutoConnect to take full advantage of both

Lighting Performance is comparable to 50-150W HPS roadway luminaires. Correlated color temperature - 4000K, or optional 2700K, 3000K or 5000K, all 70 CRI minimum. Unique IP66 rated LED light engines provided 0% uplight and restrict backlight to within sidewalk depth, providing optimal application coverage and optimal pole spacing. Available in Type II, III, IV & V roadway distributions.

ELECTRICAL Expected Life: LED light engines are rated > 100,000 hours at 25°C, L70. Electronic driver has an expected life of 100,000 hours at a 25°C ambient.

Lower Energy: Saves an expected of 40-60% over comparable HID luminaires. Robust Surge Protection: Two different surge protection options provide a minimum of ANSI C136.2 10kV/5kA or 20kV/10kA protection. Luminaire ships with a 0-10v dimmable driver or DALI D4i driver. Luminaire is continuous and step dimming capable via AO option or other installed controls.

Includes standard AEL lineman-friendly features such as tool-less entry, 3 station terminal block and quick disconnects. Bubble level located inside the electrical compartment for easily leveling at installation Rigorous pre-treatment and paint process yields a finish that achieves a scribe creepage rating of 10 (per ASTM D1654) after 5000 hours exposure to salt fog chamber (operated per ASTM B117). The optional CR finish uses an anodized basecoat with a polyester topcoat to achieve a scribe creepage rating of 10 after 10,000 hours. Mast arm mount is adjustable for arms from 1-1/4" to 2" (1-5/8" to 2-3/8" 0.D.) diameter. Provides a 3G vibration rating per ANSI C136.31

The Acuity designed ANSI 7-pin receptacle is available, which supports traditional locking style photocontrols such as the Extreme long-life solid-state locking style photocontrol - PCLL (20 year

Optional onboard Adjustable Output module allows the light output and input wattage to be modified to meet site specific requirements, and also can allow a single fixture to be flexibly applied in many different applications. The DC Connect option is a factory embedded low voltage dusk to dawn photocontrol that increases longevity vs. line voltage controls and also eliminates the need to separately inventory controls. Integral nLight rSDGR control is also available to provide local or network on/off/ dim control plus robust outdoor motion detection and response at up to 40' mounting heights. The LocalConnect option provides a simple means to collect luminaire attribute data, asset location information and execute point-to-point on/off/dim commands via secure Bluetooth link using smartphone platforms.

The Global Connect option enabled thru selection of receptacles and controls provides a smart city enabled solution utilizing long range network nodes to enable remote monitoring and control.

Additionally, it can be equipped with sensor-ready technology to support Zhaga standard sensors. Cell Connect is an embedded network photocontrol with cellular communication. It provides digital switching, precise dimming, and revenue grade metrology. Cell Connect leverage D4i drivers to communicate real-time data to UbiVu, a cloud-based asset management system.

Note: Specifications subject to change without notice. Actual performance may differ as a result of end-user environment and application. © 2023-2024 Acuity Brands Lighting, Inc. ACC 05/09/24


American Electric Lighting

American Electric Lighting

AEL Headquarters, One Lithonia Way, Convers Georgia 30012

© 2023-2024 Acuity Brands Lighting, Inc. All Rights Reserved. ACC Rev. 05/09/24

Fatigue Resistan Soft Square Steel Post Created By: -

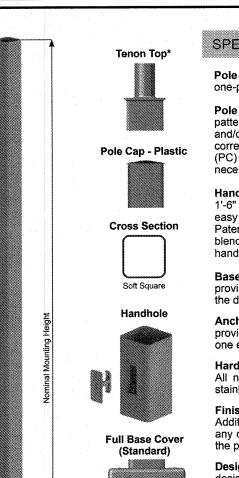


Pole Shaft - The pole shaft is fabricated from hot rolled welded steel tubing of


Pole Top - A removable pole cap is provided for poles receiving drilling patterns for side-mount luminaire arm assemblies. For top mount luminaire and/or bracket consult the factory. Consult the luminaire manufacturer for correct tenon size or drill pattern. Other pole top options include pole cap only (PC) or plain top (PL) which is typical when the pole top diameter matches the

Handhole - A reinforced handhole with grounding provision is provided at 1'-6" from the base end of the pole assembly. Each handhole includes an easy to install, self-contained Swing Latch handhole cover assembly. U.S. Patent Swing Latch cover is fabricated from durable polycarbonate/ABS blend plastic. All pole assemblies are provided with a 2.50" x 5.00" rectangular


Base Cover - A two-piece full base cover fabricated from ABS plastic is provided with each pole assembly. Additional base cover options, including

AutoConnect Series ACC **Roadway Lighting**

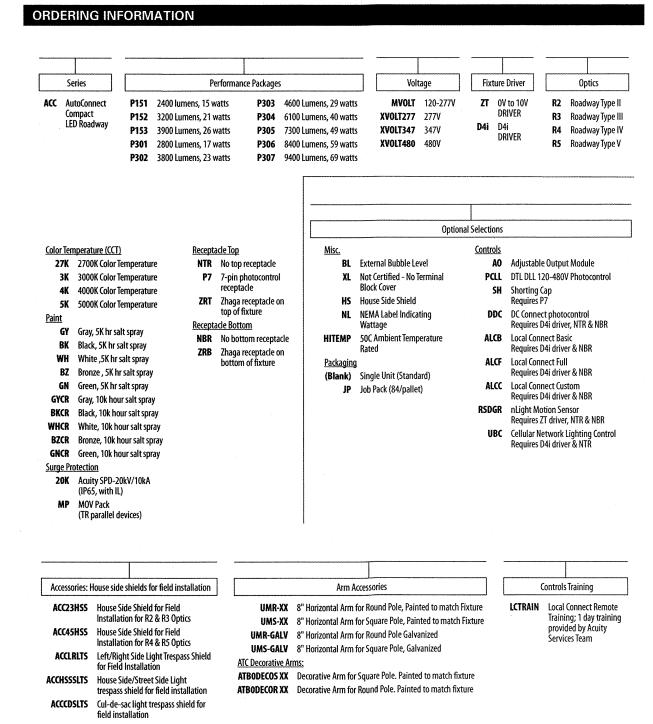

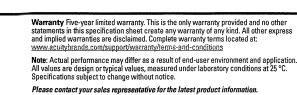




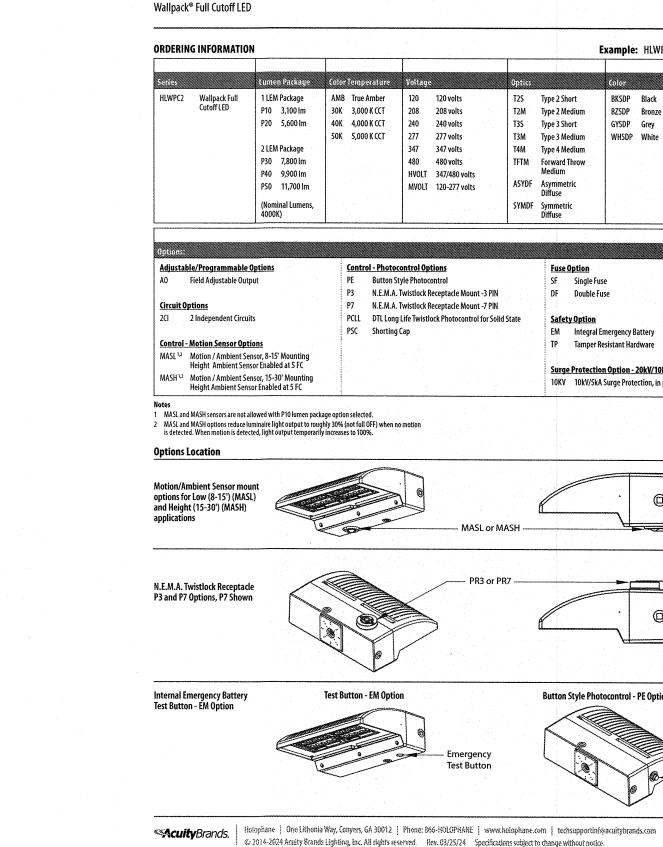

STRUCTURES

HLWPC2

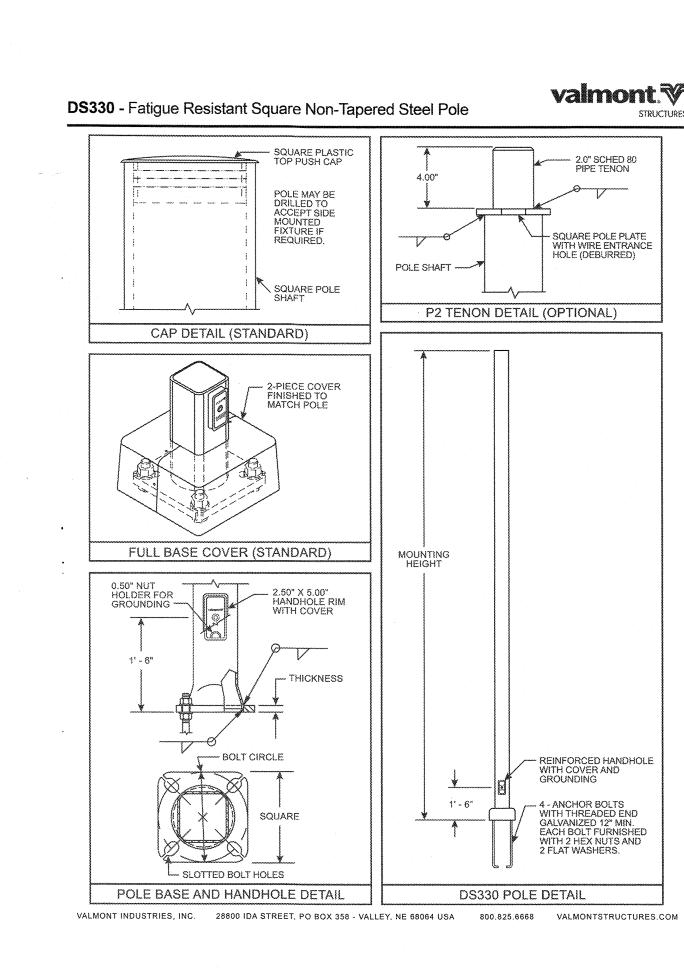



HOLOPHANE

Example: HLWPC2 P20 40K AS T3M BZSDP

BKSDP Black Blank 70 CRI (STD)

GYSDP Grey

T2M Type 2 Medium

T3M Type 3 Medium

TFTM Forward Throw Medium

ASYDF Asymmetric Diffuse

SYMDF Symmetric Diffuse

277 277 volts

347 347 volts

480 480 volts

Control - Photocontrol Options

PE Button Style Photocontrol

P3 N.E.M.A. Twistlock Receptacle Mount -3 PIN

P7 N.E.M.A. Twistlock Receptacle Mount -7 PIN

PCLL DTL Long Life Twistlock Photocontrol for Solid State

HVOLT 347/480 volts

MVOLT 120-277 volts

Type 3 Short

Type 4 Medium

SF Single Fuse

DF Double Fuse

Safety Option

EM Integral Emergency Battery

TP Tamper Resistant Hardware


Button Style Photocontrol - PE Option

Button Style


Fage 2 of 8


Surge Protection Option - 20kV/10kA is Standard

10KV 10kV/5kA Surge Protection, in place of 20kV/10kA

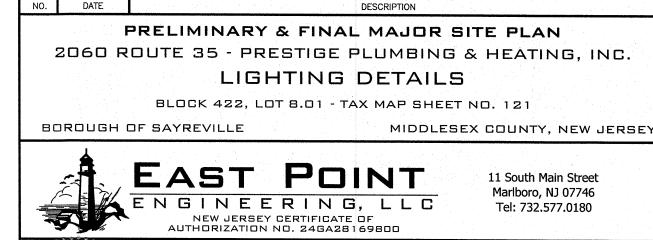

15-16-24 23-345 HECKED BY: = 20' MARC S. LEBER DATE SHEET NO. 7 OF 7 N.J. PROFESSIONAL ENGINEER, LICENSE NO. 24GE04452400 N.J. PROFESSIONAL PLANNER, LICENSE NO. 33L100589800

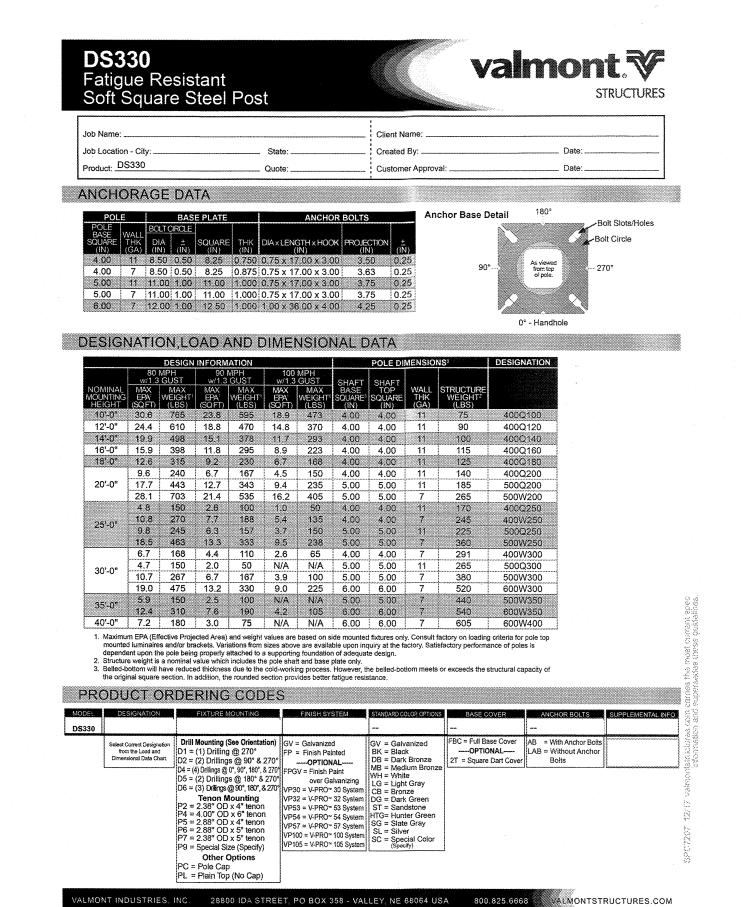

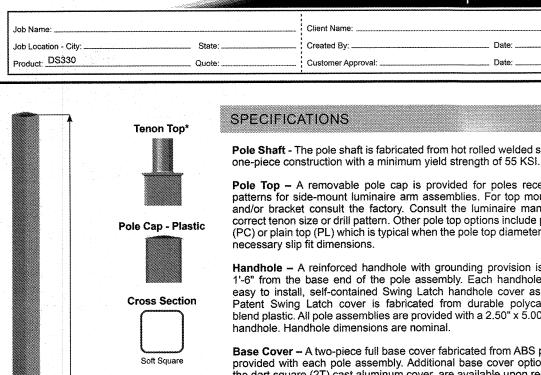

the dart square (2T) cast aluminum cover, are available upon request. Anchor Bolts - Anchor bolts conform to ASTM F1554 Grade 55 and are provided with two hex nuts and two flat washers. Bolts have an "L" bend on one end and are galvanized a minimum of 12" on the threaded end. Hardware - All structural fasteners are galvanized high strength carbon steel. All non-structural fasteners are galvanized or zinc-plated carbon steel or

Finish - Standard finishes are either Galvanized (GV) or Finish Painted (FP). Additional finish options including Finish Paint over Galvanizing (FPGV) or any of the V-PRO™ Finish Coating Systems are available upon request. See the product ordering code for color options. Design Criteria - Please reference Design Criteria Specification for appropriate design conditions. Dart Square - 27 Consult factory on loading criteria for pole top mounted

LMONT INDUSTRIES, INC. 28800 IDA STREET. PO BOX 358 - VALLEY, NE 68064 USA 800.825.6668