



AMERICAN TOWER®

ATC SITE NAME: PARLIN - SAYREVILLE

ATC SITE NUMBER: 373155 AT&T SEARCH RING: W-5836

AT&T PACE NUMBER: MRNYJ007953,

MRNYJ011805, MRNYJ011801, MRNYJ011847

AT&T SITE ID: NWL05836 AT&T FA CODE:14652316

AT&T SITE NAME: PARLIN - NYCWNJ5836 SITE ADDRESS: 775 WASHINGTON ROAD PARLIN, NJ 08859-0000



LOCATION MAP

AT&T MOBILITY COLOCATION PLAN

ATAT WODILITE COLOCATION LAN								
COMPLIANCE CODE	PROJECT SUMMARY	PROJECT DESCRIPTION		SHEET INDEX				
ALL WORK SHALL BE PERFORMED AND MATERIALS INSTALLED IN ACCORDANCE WITH THE CURRENT EDITIONS OF THE	SITE ADDRESS:		SHEET NO:	DESCRIPTION:	REV:	DATE:	BY:	
FOLLOWING CODES AS ADOPTED BY THE LOCAL GOVERNMENT AUTHORITIES. NOTHING IN THESE PLANS IS	775 WASHINGTON ROAD	THE PROPOSED PROJECT INCLUDES INSTALLING EQUIPMENT CABINETS AND A GENERATOR ON A PROPOSED	G-001	TITLE SHEET	В	03/12/12	JPB	5
TO BE CONSTRUED TO PERMIT WORK NOT CONFORMING TO THESE CODES.	PARLIN, NJ 08859-0000 COUNTY: MIDDLESEX	CONCRETE PAD INSIDE A 10' X 30' GROUND SPACE WITHIN THE EXISTING COMPOUND, AND INSTALLING NEW	G-002	GENERAL NOTES	А	01/25/21	RW	
1. 2018 INTERNATIONAL BUILDING CODE (IBC), NEW JERSEY	GEOGRAPHIC COORDINATES:	EQUIPMENT AND MOUNTS ON THE EXISTING TOWER.	C-001	OVERALL SITE PLAN	А	01/25/21	RW	
EDITION 2. 2017 NATIONAL ELECTRIC CODE (NEC)	LATITUDE: 40.46313889		C-101	DETAILED SITE PLAN	В	03/12/12	JPB	П
3. LOCAL BUILDING CODE	LONGITUDE: -74.33		C-102	DETAILED EQUIPMENT LAYOUT	В	03/12/12	JPB	П
4. CITY/COUNTY ORDINANCES	GROUND ELEVATION: 114' AMSL		C-201	TOWER ELEVATION	А	01/25/21	RW	
		PROJECT NOTES	C-401	ANTENNA INFORMATION & SCHEDULE	В	03/12/12	JPB	П
			C-501	MOUNT DETAILS	В	03/12/12	JPB	П
		1. THE FACILITY IS UNMANNED.	C-502	CONSTRUCTION DETAILS	В	03/12/12	JPB	П
	PROJECT TEAM	 A TECHNICIAN WILL VISIT THE SITE APPROXIMATELY ONCE A MONTH FOR ROUTINE INSPECTION AND MAINTENANCE. 	C-503	CONSTRUCTION DETAILS	А	01/25/21	RW	
	AMERICAN TOWER AT&T MOBILITY 10 PRESIDENTIAL WAY WOBURN, MA 01801 ENGINEER: RPM ENGINEERING LLC 875 KINGS HIGHWAY, SUITE 209	DISTURBANCE OR EFFECT OF STORM WATER DRAINAGE.	C-504	CONSTRUCTION DETAILS	В	03/12/12	JPB	П
			C-505	GENERATOR SPECIFICATIONS	A	01/25/21	RW	l
		NO SANITARY SEWER, POTABLE WATER OR TRASH DISPOSAL IS REQUIRED.	E-101	GROUNDING DETAILS & ELECTRICAL SCHEMATIC	В	03/12/12	JPB	
UTILITY COMPANIES		5. HANDICAP ACCESS IS NOT REQUIRED.	E-102	GROUNDING DETAIL	А	01/25/21	RW]
POWER COMPANY: FIRST ENERGY COS PHONE: (888) 544-4877			E-501	GROUNDING DETAILS	A	01/25/21	RW	
TELEPHONE COMPANY: VERIZON		PROJECT LOCATION DIRECTIONS	E-601	PANEL SCHEDULE	A	01/25/21	RW	, C
PHONE: (800) 837-4966	PROPERTY OWNER:	TROSECT ECOATION BIRECTIONS	R-601	SUPPLEMENTAL				C
677	COLUMBUS CLUB		R-602	SUPPLEMENTAL				П
	775 WASHINGTON ROAD - PARLIN - NJ - 08859	FROM NORTH JERSEY/NY AREA -TAKE NJ TURNPIKE SOUTH TO	R-603	SUPPLEMENTAL				
	AMERICAN TOWER	ROUTE 9 SOUTH TO ERNSTON RD WEST TO WASHINGTON MAKE RIGHT ,MAKE A RIGHT ON SHREE TOWARD HISH TEMPLE.	R-604	SUPPLEMENTAL				1 L
Know what's below.	116 HUNTINGTON AVE BOSTON, MA 02116	TOWER IS ON RIGHT.	R-605	SUPPLEMENTAL				11
Call before you dig.			R-606	SUPPLEMENTAL				11





REV.	DESCRIPTION	BY	DATE
\triangle_{-}	PRELIM	RW	01/25/21
B_	REVISED PER COMMENTS	<u>JPB</u>	03/12/21
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ATC SITE NAME: PARLIN - SAYREVILLE

AT&T MOBILITY SITE NAME:

PARLIN - NYCWNJ5836

SITE ADDRESS: 775 WASHINGTON ROAD PARLIN, NJ 08859-0000



DATE DRAWN:	01/20/21
ATC JOB NO:	13325346_G2
CUSTOMER ID:	NWL05836
CUSTOMER #:	14652316

TITLE SHEET

G-001

GENERAL CONSTRUCTION NOTES:

- OWNER FURNISHED MATERIALS, AT&T MOBILITY "THE COMPANY" WILL PROVIDE AND THE 22. CONTRACTOR WILL INSTALL
- A. BTS EQUIPMENT FRAME (PLATFORM) AND ICEBRIDGE SHELTER (GROUND BUILD/CO-LOCATE ONLY)
- B. AC/TELCO INTERFACE BOX (PPC)
- C. ICE BRIDGE (CABLE TRAY WITH COVER) (GROUND BUILD/CO-LOCATE ONLY, GC TO FURNISH AND INSTALL FOR ROOFTOP INSTALLATION)
- D. TOWERS, MONOPOLES
- E. TOWER LIGHTING
- F. GENERATORS & LIQUID PROPANE TANK
- G. ANTENNA STANDARD BRACKETS. FRAMES AND PIPES FOR MOUNTING
- H. ANTENNAS (INSTALLED BY OTHERS)
- TRANSMISSION LINE
- J. TRANSMISSION LINE JUMPERS
- K. TRANSMISSION LINE CONNECTORS WITH WEATHERPROOFING KITS
- L. TRANSMISSION LINE GROUND KITS
- M. HANGERS
- N. HOISTING GRIPS
- O. BTS EQUIPMENT
- 2. THE CONTRACTOR IS RESPONSIBLE TO PROVIDE ALL OTHER MATERIALS FOR THE COMPLETE INSTALLATION OF THE SITE INCLUDING, BUT NOT LIMITED TO, SUCH MATERIALS AS FENCING, STRUCTURAL STEEL SUPPORTING SUB-FRAME FOR PLATFORM ROOFING LABOR AND MATERIALS, GROUNDING RINGS, GROUNDING WIRES, COPPER-CLAD OR XIT CHEMICAL GROUND ROD(S), BUSS BARS, TRANSFORMERS AND DISCONNECT SWITCHES WHERE APPLICABLE, TEMPORARY ELECTRICAL POWER, CONDUIT, LANDSCAPING COMPOUND STONE, CRANES, CORD EDILLING, SLEEPERS AND RUBBER MATTING, REBAR, CONCRETE CAISSONS, PADS AND/OR AUGER MOUNTS, MISCELLANEOUS FASTENERS, CABLE TRAYS, NON-STANDARD ANTENNA FRAMES AND ALL OTHER MATERIAL AND LABOR REQUIRED TO COMPLETE THE JOB ACCORDING TO THE DRAWINGS AND SPECIFICATIONS. IT IS THE POSITION OF AT&T MOBILITY TO APPLY FOR PERMITTING AND CONTRACTOR RESPONSIBLE FOR PICKUP AND PAYMENT OF REQUIRED PERMITS.
- ALL WORK SHALL CONFORM TO ALL CURRENT APPLICABLE FEDERAL, STATE, AND LOCAL CODES, INCLUDING ANSI/EIA/TIA-222, AND COMPLY WITH ATC CONSTRUCTION SPECIFICATIONS.
- CONTRACTOR SHALL CONTACT LOCAL 811 FOR IDENTIFICATION OF UNDERGROUND UTILITIES PRIOR TO START OF CONSTRUCTION.
- CONTRACTOR SHALL BE RESPONSIBLE FOR COORDINATING ALL REQUIRED INSPECTIONS.
- ALL DIMENSIONS TO, OF, AND ON EXISTING BUILDINGS, DRAINAGE STRUCTURES, AND SITE IMPROVEMENTS SHALL BE VERRIED IN FIELD BY CONTRACTOR WITH ALL DISCREPANCIES REPORTED TO THE ENGINEER.
- 7. DO NOT CHANGE SIZE OR SPACING OF STRUCTURAL ELEMENTS.
- DETAILS SHOWN ARE TYPICAL; SIMILAR DETAILS APPLY TO SIMILAR CONDITIONS UNLESS
 OTHERWISE NOTED.
 32.
- THESE DRAWINGS DO NOT INCLUDE NECESSARY COMPONENTS FOR CONSTRUCTION SAFETY WHICH SHALL BE THE SOLE RESPONSIBILITY OF THE CONTRACTOR.
- CONTRACTOR SHALL BRACE STRUCTURES UNTIL ALL STRUCTURAL ELEMENTS NEEDED FOR STABILITY ARE INSTALLED. THESE ELEMENTS ARE AS FOLLOWS: LATERAL BRACING, ANCHOR BOLTS. FTC.
- CONTRACTOR SHALL DETERMINE EXACT LOCATION OF EXISTING UTILITIES, GROUNDS DRAINS, DRAIN PIPES, VENTS, ETC. BEFORE COMMENCING WORK.
- 12. INCORRECTLY FABRICATED, DAMAGED, OR OTHERWISE MISFITTING OR NONCONFORMING MATERIALS OR CONDITIONS SHALL BE REPORTED TO THE AT&T MOBILITY REP PRIOR TO REMEDIAL OR CORRECTIVE ACTION. ANY SUCH REMEDIAL ACTION SHALL REQUIRE WRITTEN APPROVAL BY THE AT&T MOBILITY REP PRIOR TO PROCEEDING.
- 13. EACH CONTRACTOR SHALL COOPERATE WITH THE AT&T MOBILITY REP, AND COORDINATE HIS WORK WITH THE WORK OF OTHERS.
- 14. CONTRACTOR SHALL REPAIR ANY DAMAGE CAUSED BY CONSTRUCTION OF THIS PROJECT TO MATCH EXISTING PRE-CONSTRUCTION CONDITIONS TO THE SATISFACTION OF THE AT&T MOBILITY CONSTRUCTION MANAGER
- ALL CABLE/CONDUIT ENTRY/EXIT PORTS SHALL BE WEATHERPROOFED DURING INSTALLATION USING A SILICONE SEALANT.
- WHERE EXISTING CONDITIONS DO NOT MATCH THOSE SHOWN IN THIS PLAN SET, CONTRACTOR SHALL NOTIFY THE AT&T MOBILITY REP AND ENGINEER OF RECORD
- 17. CONTRACTOR SHALL ENSURE ALL SUBCONTRACTORS ARE PROVIDED WITH A COMPLETE AND CURRENT SET OF DRAWINGS AND SPECIFICATIONS FOR THIS PROJECT.
- 18. CONTRACTOR SHALL REMOVE ALL RUBBISH AND DEBRIS FROM THE SITE AT THE END OF 3.
- CONTRACTOR SHALL COORDINATE WORK SCHEDULE WITH AMERICAN TOWER CORPORATION (ATC) AND TAKE PRECAUTIONS TO MINIMIZE IMPACT AND DISRUPTION OF OTHER OCCUPANTS OF THE FACILITY.
- CONTRACTOR SHALL FURNISH AT&T MOBILITY AND AMERICAN TOWER CORPORATION
 (ATC) WITH A PDF MARKED UP AS-BUILT SET OF DRAWINGS UPON COMPLETION OF
 WORD WITH A PDF MARKED UP AS-BUILT SET OF DRAWINGS UPON COMPLETION OF
- PRIOR TO SUBMISSION OF BID, CONTRACTOR SHALL COORDINATE WITH AT&T MOBILITY REP TO DETERMINE WHAT, IF ANY, ITEMS WILL BE PROVIDED. ALL ITEMS NOT PROVIDED SHALL BE PROVIDED AND INSTALLED BY THE CONTRACTOR. CONTRACTOR WILL INSTALL

- ALL ITEMS PROVIDED.
- 22. PRIOR TO SUBMISSION OF BID, CONTRACTOR SHALL COORDINATE WITH AT&T MOBILITY REP TO DETERMINE IF ANY PERMITS WILL BE OBTAINED BY CONTRACTOR. ALL REQUIRED PERMITS NOT OBTAINED BY AT&T MOBILITY MUST BE OBTAINED, AND PAID FOR BY THE CONTRACTOR.
- 23. CONTRACTOR SHALL INSTALL ALL SITE SIGNAGE IN ACCORDANCE WITH AT&T MOBILITY SPECIFICATIONS AND REQUIREMENTS.
- CONTRACTOR SHALL SUBMIT ALL SHOP DRAWINGS TO AT&T MOBILITY FOR REVIEW AND APPROVAL PRIOR TO FABRICATION.
- ALL EQUIPMENT SHALL BE INSTALLED ACCORDING TO MANUFACTURER'S SPECIFICATIONS AND LOCATED ACCORDING TO AT&T MOBILITY SPECIFICATIONS, AND AS SHOWN IN THESE PLANS.
- 26. THE CONTRACTOR SHALL SUPERVISE AND DIRECT THE PROJECT DESCRIBED HEREIN. THE CONTRACTOR SHALL BE SOLELLY RESPONSIBLE FOR ALL THE CONSTRUCTION MEANS, METHODS, TECHNIQUES, SEQUENCES AND PROCEDURES AND FOR COORDINATING ALL PORTIONS OF THE WORK UNDER THE CONTRACT
- 27. CONTRACTOR SHALL NOTIFY AT&T MOBILITY REP A MINIMUM OF 48 HOURS IN ADVANCE OF POURING CONCRETE OR BACKFILLING ANY UNDERGROUND UTILITIES, FOUNDATIONS OR SEALING ANY WALL, FLOOR OR ROOF PENETRATIONS FOR ENGINEERING REVIEW
- 28. CONTRACTOR SHALL BE RESPONSIBLE FOR SITE SAFETY INCLUDING COMPLIANCE WITH ALL APPLICABLE OSHA STANDARDS AND RECOMMENDATIONS AND SHALL PROVIDE ALL NECESSARY SAFETY DEVICES INCLUDING PPE AND PPM AND CONSTRUCTION DEVICES SUCH AS WELDING AND FIRE PREVENTION, TEMPORARY SHORING, SCAFFOLDING, TRENCH BOXES/SLOPING, BARRIERS, ETC.
- 29. THE CONTRACTOR SHALL PROTECT AT HIS OWN EXPENSE, ALL EXISTING FACILITIES AND SUCH OF HIS NEW WORK LIABLE TO INJURY DURING THE CONSTRUCTION PERIOD. ANY DAMAGE CAUSED BY NEGLECT ON THE PART OF THIS CONTRACTOR OR HIS REPRESENTATIVES, OR BY THE ELEMENTS DUE TO NEGLECT ON THE PART OF THIS CONTRACTOR OR HIS REPRESENTATIVES, EITHER TO THE EXISTING WORK, OR TO HIS WORK OR THE WORK OF ANY OTHER CONTRACTOR, SHALL BE REPAIRED AT HIS EXPENSE TO THE OWNER'S SATISFACTION.
- 30. ALL WORK SHALL BE INSTALLED IN A FIRST CLASS, NEAT AND WORKMANLIKE MANNER BY MECHANICS SKILLED IN THE TRADE INVOLVED. THE QUALITY OF WORKMANSHIP SHALL BE SUBJECT TO THE APPROVAL OF THE ATAK MOBILITY REP. ANY WORK FOUND BY THE AT&T MOBILITY REP TO BE OF INFERIOR QUALITY AND/OR WORKMANSHIP SHALL BE REPLACED AND/OR REWORKED AT CONTRACTOR EXPENSE UNTIL APPROVAL IS OBTAINED.
- IN ORDER TO ESTABLISH STANDARDS OF QUALITY AND PERFORMANCE, ALL TYPES OF MATERIALS LISTED HEREINAFTER BY MANUFACTURER'S NAMES AND/OR MANUFACTURER'S CATALOG NUMBER SHALL BE PROVIDED BY THESE MANUFACTURERS AS SPECIFIED.
- 32. AT&T MOBILITY FURNISHED EQUIPMENT SHALL BE PICKED-UP AT THE AT&T MOBILITY WAREHOUSE, NO LATER THAN 48HR AFTER BEING NOTIFIED INSURED, STORED, UNCRATE, PROTECTED AND INSTALLED BY THE CONTRACTOR WITH ALL APPURTENANCES REQUIRED TO PLACE THE EQUIPMENT IN OPERATION, READY FOR USE. THE CONTRACTOR SHALL BE RESPONSIBLE FOR THE EQUIPMENT AFTER PICKING IT UP.
- 33. AT&T MOBILITY OR HIS ARCHITECT/ENGINEER RESERVES THE RIGHT TO REJECT ANY EQUIPMENT OR MATERIALS WHICH, IN HIS OWN OPINION ARE NOT IN COMPLIANCE WITH THE CONTRACT DOCUMENTS, EITHER BEFORE OR AFTER INSTALLATION AND THE EQUIPMENT SHALL BE REPLACED WITH EQUIPMENT CONFORMING TO THE REQUIREMENTS OF THE CONTRACT DOCUMENTS BY THE CONTRACTOR AT NO COST TO AT&T MOBILITY OR THEIR ARCHITECT/ENGINEER.

STRUCTURAL STEEL NOTES:

- STRUCTURAL STEEL SHALL CONFORM TO THE LATEST EDITION OF THE AISC "SPECIFICATION FOR THE DESIGN, FABRICATION AND ERECTION OF STRUCTURAL STEEL EOP BILLIONICS."
- STRUCTURAL STEEL ROLLED SHAPES, PLATES AND BARS SHALL CONFORM TO THE FOLLOWING ASTM DESIGNATIONS:
 - A. ASTM A-572, GRADE 50 ALL W SHAPES, UNLESS NOTED OR A992 OTHERWISE
 - B. ASTM A-36 ALL OTHER ROLLED SHAPES, PLATES AND BARS UNLESS NOTED OTHERWISE.
 - C. ASTM A-500, GRADE B HSS SECTION (SQUARE, RECTANGULAR, AND ROUND)
 - D. ASTM A-325, TYPE SC OR N $\,$ ALL BOLTS FOR CONNECTING STRUCTURAL MEMBERS
 - E. ASTM F-1554 07 ALL ANCHOR BOLTS, UNLESS NOTED OTHERWISE
- ALL EXPOSED STRUCTURAL STEEL MEMBERS SHALL BE HOT-DIPPED GALVANIZED AFTER
 FABRICATION PER ASTM A123. EXPOSED STEEL HARDWARE AND ANCHOR BOLTS SHALL
 BE GALVANIZED PER ASTM A153 OR B695.
 3.
- ALL FIELD CUT SURFACES, FIELD DRILLED HOLES AND GROUND SURFACES WHERE EXISTING PAINT OR GALVANIZATION REMOVAL WAS REQUIRED SHALL BE REPAIRED WITH (2) BRUSHED COATS OF ZRC GALVILITE COLD GALVANIZING COMPOUND PER ASTM A780 AND MANUFACTURER'S RECOMMENDATIONS.
- DO NOT DRILL HOLES THROUGH STRUCTURAL STEEL MEMBERS EXCEPT AS SHOWN AND DETAILED ON STRUCTURAL DRAWINGS.
- . CONNECTIONS:

- A. ALL WELDING TO BE PERFORMED BY AWS CERTIFIED WELDERS AND CONDUCTED IN ACCORDANCE WITH THE LATEST EDITION OF THE AWS WELDING CODE D1.1.
- B. ALL WELDS SHALL BE INSPECTED VISUALLY, 25% OF WELDS SHALL BE INSPECTED WITH DYE PENETRANT OR MAGNETIC PARTICLE TO MEET THE ACCEPTANCE CRITERIA OF AWS D1.1. REPAIR ALL WELDS AS NECESSARY.
- C. INSPECTION SHALL BE PERFORMED BY AN AWS CERTIFIED WELD INSPECTOR.
- D. IT IS THE CONTRACTORS RESPONSIBILITY TO PROVIDE BURNING/WELDING PERMITS AS REQUIRED BY LOCAL GOVERNING AUTHORITY AND IF REQUIRED SHALL HAVE FIRE DEPARTMENT DETAIL FOR ANY WELDING ACTIVITY.
- E. ALL ELECTRODES TO BE LOW HYDROGEN, MATCHING FILLER METAL, PER AWS D1.1, UNLESS NOTED OTHERWISE.
- F. MINIMUM WELD SIZE TO BE 0.1875 INCH FILLET WELDS, UNLESS NOTED OTHERWISE.
- G. PRIOR TO FIELD WELDING GALVANIZING MATERIAL, CONTRACTOR SHALL GRIND OFF GALVANIZING % BEYOND ALL FIELD WELD SURFACES. AFTER WELD AND WELD INSPECTION IS COMPLETE, REPAIR ALL GROUND AND WELDED SURFACES WITH ZRC GALVILITE COLD GALVANIZING COMPOUND PER ASTM A780 AND MANUFACTURERS RECOMMENDATIONS.
- H. THE CONTRACTOR SHALL PROVIDE ADEQUATE SHORING AND/OR BRACING WHERE REQUIRED DURING CONSTRUCTION UNTIL ALL CONNECTIONS ARE COMPLETE.
- I. ANY FIELD CHANGES OR SUBSTITUTIONS SHALL HAVE PRIOR APPROVAL FROM
 THE ENGINEER, AND T. MORII E PROJECT MANAGER IN WRITING

SPECIAL CONSTRUCTION ANTENNA INSTALLATION NOTES:

- WORK INCLUDED
 - A. ANTENNA AND COAXIAL CABLES ARE FURNISHED BY AT&T MOBILITY UNDER A SEPARATE CONTRACT. THE CONTRACTOR SHALL ASSIST ANTENNA INSTALLATION CONTRACTOR IN TERMS OD COORDINATION AND SITE ACCESS. ERECTION SUBCONTRACTOR SHALL BE RESPONSIBLE FOR THE PROTECTION OF PERSONNEL AND
 - B. INSTALL ANTENNA AS INDICATE ON DRAWINGS AND AT&T MOBILITY SPECIFICATIONS.
 - C. INSTALL GALVANIZED STEEL ANTENNA MOUNTS AS INDICATED ON DRAWINGS
 - D. INSTALL FURNISHED GALVANIZED STEEL OR ALUMINUM WAVEGUIDE AND PROVIDE PRINTOUT OF THAT TEST.
 - E. CONTRACTOR SHALL PROVIDE FOUR (4) SETS OF SWEEP TESTS USING ANRITZU-PACKARD 8713B RF SCALAR NETWORK ANALYZER. SUBMIT FREQUENCY DOMAIN REFLECTOMETER(FDR) TESTS RESULTS TO THE PROJECT MANAGER. SWEEP TESTS SHALL BE AS PER ATTACHED RFS "MINIMUM FIELD TESTING RECOMMENDED FOR ANTENNA AND HELIAX COAXIAL CABLE SYSTEMS" DATED 10/5/93. TESTING SHALL BE PERFORMED BY AN INDEPENDENT TESTING SERVICE AND BE BOUND AND SUBMITTED WITHIN ONE WEEK OF WORK COMPLETION.
 - F. INSTALL COAXIAL CABLES AND TERMINATING BETWEEN ANTENNAS AND EQUIPMENT PER MANUFACTURER'S RECOMMENDATIONS. WEATHERPROOF ALL CONNECTIONS BETWEEN THE ANTENNA AND EQUIPMENT PER MANUFACTURER'S REQUIREMENTS. TERMINATE ALL COAXIAL CABLE THREE (3) FEET IN EXCESS OF ENTRY PORT LOCATION UNLESS OTHERWISE STATED.
 - G. ANTENNA AND COAXIAL CABLE GROUNDING:
- ALL EXTERIOR #6 GREED GROUND WIRE "DAISY CHAIN" CONNECTIONS ARE TO BE
 WEATHER SEALED WITH RFS CONNECTORS/SPLICE WEATHERPROOFING KIT #221213 OR
 ECOLUMN

 TO SERVICE OF THE PROOFING HIS PROOFING HIS
- ALL COAXIAL CABLE GROUNDING KITS ARE TO BE INSTALLED ON STRAIGHT RUNS OF COAXIAL CABLE (NOT WITHIN BENDS)

CONCRETE AND REINFORCING STEEL NOTES:

- DESIGN AND CONSTRUCTION OF ALL CONCRETE ELEMENTS SHALL CONFORM TO THE LATEST EDITIONS OF ALL APPLICABLE CODES INCLUDING: ACI 301 "SPECIFICATIONS FOR STRUCTURAL CONCRETE FOR BUILDINGS", ACI 117 "SPECIFICATIONS FOR TOLERANCES FOR CONCRETE CONSTRUCTION AND MATERIALS", AND ACI 318 "BUILDING CODE REQUIREMENTS FOR REINFORCED CONCRETE."
- MIX DESIGN SHALL BE APPROVED BY AT&T MOBILITY REP PRIOR TO PLACING CONCRETE.
- CONCRETE SHALL BE NORMAL WEIGHT, 6 % AIR ENTRAINED (+/- 1.5%) WITH A SLUMP RANGE OF 3-6" AND HAVE A MINIMUM 28-DAY COMPRESSIVE STRENGTH OF 4000 PSI UNLESS OTHERWISE NOTED.
- 4. THE FOLLOWING MATERIALS SHALL BE USED:

PORTLAND CEMENT: ASTM C150, TYPE 2

REINFORCEMENT: ASTM A185. PLAIN STEEL WELDED WIRE FABRIC

REINFORCEMENT BARS: ASTM A615, GRADE 60, DEFORMED

NORMAL WEIGHT AGGREGATE: ASTM C33 WATER: ASTM C 94/C 94N

WELDED WIRE FABRIC: ASTM A185
ADMIXTURES:

-WATER-REDUCING AGENT: ASTM C 494/C 494M, TYPE A

-AIR-ENTERING AGENT: ASTM C 260/C 260M

-SUPERPLASTICIZER: ASTM C494, TYPE F OR TYPE G
-RETARDING: ASTM C 494/C 494M. TYPE B

- MINIMUM CONCRETE COVER FOR REINFORCING STEEL SHALL BE NO LESS THAN 3".
- A 3/4" CHAMFER SHALL BE PROVIDED AT ALL EXPOSED EDGES OF CONCRETE IN ACCORDANCE WITH ACI 301 SECTION 4.2.4. UNLESS NOTED OTHERWISE.
- INSTALLATION OF CONCRETE EXPANSION/WEDGE ANCHOR SHALL BE PER MANUFACTURER'S WRITTEN RECOMMENDED PROCEDURE. THE ANCHOR BOLT, DOWEL OR ROD SHALL CONFORM TO MANUFACTURER'S RECOMMENDATION FOR EMBEDMENT DEPTH OR AS SHOWN ON THE DRAWINGS. NO REBAR SHALL BE CUT WITHOUT PRIOR APPROVAL FROM AN ATC ENGINEER WHEN DRILLING HOLES IN CONCRETE.
- ADMIXTURES SHALL CONFORM TO THE APPROPRIATE ASTM STANDARD AS REFERENCED IN "METHOD 1" OF ACI 301.
- DO NOT WELD OR TACK WELD REINFORCING STEEL.
- ALL DOWELS, ANCHOR BOLTS, EMBEDDED STEEL, ELECTRICAL CONDUITS, PIPE SLEEVES, GROUNDS AND ALL OTHER EMBEDDED ITEMS AND FORMED DETAILS SHALL BE IN PLACE BEFORE START OF CONCRETE PLACEMENT.
- 11. REINFORCEMENT SHALL BE COLD BENT WHENEVER BENDING IS REQUIRED.
- 12. DO NOT PLACE CONCRETE IN WATER, ICE, OR ON FROZEN GROUND.
- FOR COLD-WEATHER (ACI 306) AND HOT-WEATHER (ACI 301M) CONCRETE PLACEMENT, CONFORM TO APPLICABLE ACI CODES AND RECOMMENDATIONS. IN EITHER CASE, MATERIALS CONTAINING CHLORIDE, CALCIUM, SALTS, ETC. SHALL NOT BE USED. PROTECT FRESH CONCRETE FROM WEATHER FOR 7 DAYS, MINIMUM.
- 14. ALL CONCRETE SHALL HAVE A "SMOOTH FORM FINISH."
- 15. SPLICING OF REINFORCEMENT IS PERMITTED ONLY AT LOCATIONS SHOWN IN THE CONTRACT DRAWINGS OR AS ACCEPTED BY THE ENGINEER. UNLESS OTHERWISE SHOWN OR NOTED REINFORCING STEEL SHALL BE SPLICED TO DEVELOP ITS FULL TENSILE CAPACITY (CLASS A) IN ACCORDANCE WITH ACI 318.
- DETAILING OF REINFORCING STEEL SHALL CONFORM TO "ACI MANUAL OF STANDARD PRACTICE FOR DETAILING REINFORCED CONCRETE STRUCTURES" (ACI 315).
- 17. ALL SLAB CONSTRUCTION SHALL BE CAST MONOLITHICALLY WITHOUT HORIZONTAL CONSTRUCTION JOINTS. UNLESS SHOWN IN THE CONTRACT DRAWINGS.
- 18. LOCATION OF ALL CONSTRUCTION JOINTS ARE SUBJECT TO THE REQUIREMENTS OF THE CONTRACT DOCUMENTS, CONFORMANCE WITH ACI 318, AND ACCEPTANCE OF THE ENGINEER. DRAWINGS SHOWING LOCATION OF DETAILS OF THE PROPOSED CONSTRUCTION JOINTS SHALL BE SUBMITTED WITH REINFORCING STEEL PLACEMENT DRAWINGS
- SPLICES OF WWF, AT ALL SPLICED EDGES, SHALL BE SUCH THAT THE OVERLAP MEASURED BETWEEN OUTERMOST CROSS WIRES OF EACH FABRIC SHEET IS NOT LESS THAN THE SPACING OF THE CROSS WIRE PLUS 2 INCHES. NOR LESS THAN 67.
- 20. BAR SUPPORTS SHALL BE ALL-GALVANIZED METAL WITH PLASTIC TIPS.
- 21. ALL REINFORCEMENT SHALL BE SECURELY TIED IN PLACE TO PREVENT DISPLACEMENT BY CONSTRUCTION TRAFFIC OR CONCRETE. TIE WIRE SHALL BE OF SUFFICIENT STRENGTH FOR INTENDED PURPOSE BUT NOT LESS THAN NO. 18 GAUGE
- 22. SLAB ON GROUND: COMPACT STRUCTURAL FILL TO 95% DENSITY AND THEN PLACE 6" GRAVEL BENEATH SLAB.

ELECTRICAL NOTES:

- ELECTRICAL DESIGN SHALL BE PERFORMED BY ELECTRICAL CONTRACTOR.
 STRUCTURAL DESIGN SHALL BE PERFORMED BY GENERAL CONTRACTOR. ELECTRICAL
 CONTRACTOR SHALL ENSURE THAT ALL WORK COMPLIES WITH ALL APPLICABLE LOCAL
 AND STATE CODES AND NATIONAL ELECTRICAL CODE.
- 2. ALL SUGGESTED ELECTRICAL ELEMENTS (SUCH AS BREAKER SIZES, WIRE SIZES, CONDUITS SIZES ARE FOR ZONING PURPOSES ONLY. IT IS THE RESPONSIBILITY TO OF THE ELECTRICAL CONTRACTOR TO CONFIRM COMPLIANCE WITH LOCAL ELECTRICAL CODES AND PASS ALL APPLICABLE AND NECESSARY INSPECTIONS. IN SOME EVENTS, IT MAY BE NECESSARY TO PERFORM AN ELECTRICAL LOAD STUDY TO VERIFY THE CAPACITY OF THE EXISTING SERVICE. THIS IS NOT THE RESPONSIBILITY OF CONCORDIA IT IS THE RESPONSIBILITY OF THE ELECTRICAL CONTRACTOR.
- . CONTRACTOR SHALL FIELD LOCATE ALL BELOW GRADE GROUND LINES AND UTILITY LINES PRIOR TO CONSTRUCTION. CONTRACTOR IS RESPONSIBLE FOR RELOCATION OF ALL UTILITIES AND GROUND LINES THAT MAY BECOME DISTURBED OR CONFLICTING IN THE COURSE OF CONSTRUCTION.

ALL DISCREPANCIES FROM WHAT IS SHOWN ON THESE CONSTRUCTION DRAWINGS SHALL BE COMMUNICATED TO ATC ENGINEERING IMMEDIATELY FOR CORRECTION OR RE-DESIGN. FAILURE TO COMMUNICATE DIRECTLY WITH ATC ENGINEERING OR ANY CHANGES FROM THE DESIGN CONDUCTED WITHOUT PRIOR APPROVAL FROM ATC ENGINEERING SHALL BE THE SOLE RESPONSIBILITY OF THE GENERAL CONTRACTOR.



COA: 24GA28099400



PRELIM RW 01/25/2	REV.	DESCRIPTION	BY	DATE
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ATC SITE NUMBER: 373155

ATC SITE NAME:
PARLIN - SAYREVILLE

AT&T MOBILITY SITE NAME:

PARLIN - NYCWNJ5836
SITE ADDRESS:
775 WASHINGTON ROAD

PARLIN. NJ 08859-0000

SEAL:

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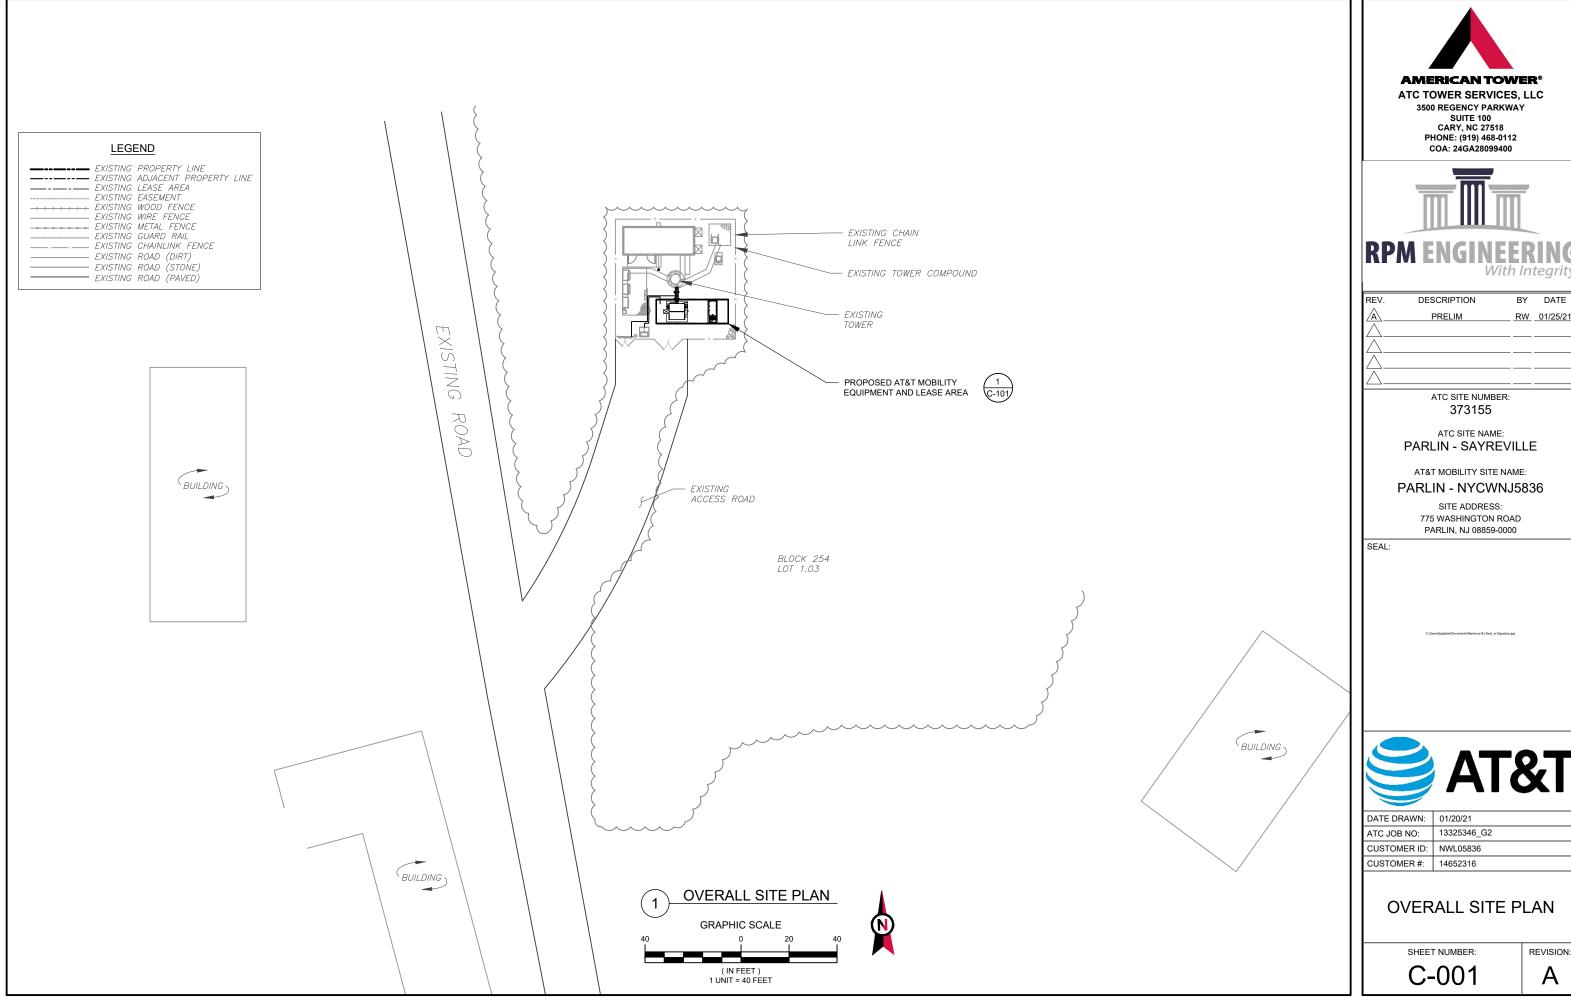
DATE DRAWN: 01/20/21
ATC JOB NO: 13325346_G2
CUSTOMER ID: NWL05836
CUSTOMER #: 14652316

GENERAL NOTES

SHEET NUMBER

G-002

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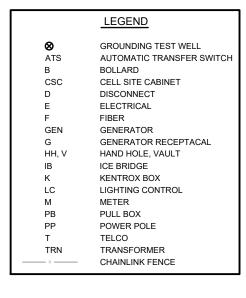
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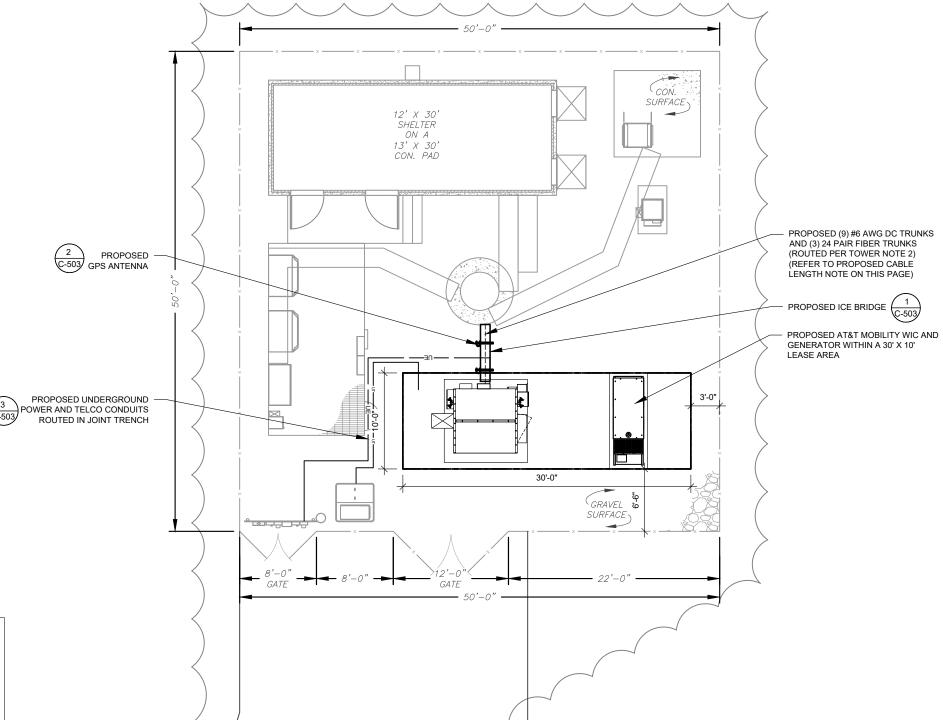


	DATE DRAWN:	01/20/21
	ATC JOB NO:	13325346_G2
	CUSTOMER ID:	NWL05836
	CUSTOMER #:	14652316

SITE PLAN NOTES:


- 1. THIS SITE PLAN REPRESENTS THE BEST PRESENT KNOWLEDGE AVAILABLE TO THE ENGINEER AT THE TIME OF THIS DESIGN. THE CONTRACTOR SHALL VISIT THE SITE PRIOR TO CONSTRUCTION AND VERIFY ALL EXISTING CONDITIONS RELATED TO THE SCOPE OF WORK FOR THIS PROJECT.
- ICE BRIDGE, CABLE LADDER, COAX PORT, AND COAX CABLE ARE SHOWN FOR REFERENCE ONLY. CONTRACTOR SHALL CONFIRM THE EXACT LOCATION OF ALL
 PROPOSED AND EXISTING EQUIPMENT AND STRUCTURES DEPICTED ON THIS PLAN. BEFORE UTILIZING EXISTING CABLE SUPPORTS, COAX PORTS, INSTALLING NEW
 PORTS OR ANY OTHER EQUIPMENT, CONTRACTOR SHALL VERIFY ALL ASPECTS OF THE COMPONENTS MEET THE ATC SPECIFICATIONS.
- 3. IT IS THE RESPONSIBILITY OF THE CONTRACTOR TO COORDINATE WITH THE AT&T MOBILITY REPRESENTATIVE AND LOCAL UTILITY COMPANY FOR THE INSTALLATION OF CONDUITS, CONDUCTORS, BREAKERS, DISCONNECTS, OR ANY OTHER EQUIPMENT REQUIRED FOR ELECTRICAL SERVICE. ALL ELECTRICAL WORK SHALL BE PERFORMED IN ACCORDANCE WITH LATEST EDITION OF THE STATE AND NATIONAL CODES, ORDINANCES AND REGULATIONS APPLICABLE TO THIS PROJECT.





PROPOSED CABLE LENGTH:

- . ESTIMATED LENGTH OF PROPOSED CABLE IS 115'.
 ESTIMATED LENGTH OF CABLE WAS PROVIDED BY
 CUSTOMER OR CALCULATED BY ADDING THE RAD
 CENTER AND THE DISTANCE FROM THE SHELTER
 ENTRY PLATE TO THE TOWER (ALONG THE ICE
 BRIDGE) AND A SAFETY FACTOR MEASUREMENT OF
 15% (OF THE TWO PREVIOUS VALUES), CDS DEFER
 TO GREATEST CABLE LENGTH.
- 2. ROUTE PROPOSED CABLES ALONG SAME PATH AS EXISTING CABLES AND IN ACCORDANCE WITH STRUCTURAL ANALYSIS. IF ADEQUATE SPACE EXISTS, ROUTE CABLES THROUGH ENTRY PORT HOLE, UP INSIDE OF MONOPOLE, AND THROUGH EXIT PORT HOLE. IF ROUTING OUTSIDE THE MONOPOLE, ATTACH CABLES USING STAND-OFF ADAPTERS MOUNTED TO TOWER USING STAINLESS STEEL BANDING. ADEQUATELY SECURE CABLES USING EITHER APPROPRIATELY SIZED STAINLESS STEEL SNAP-INS OR MOUNTING HARDWARE AND BRACKETS AS SPECIFIED BY CABLE MANUFACTURER.

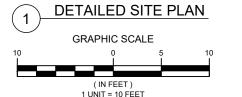





ATC TOWER SERVICES, LLC

3500 REGENCY PARKWAY SUITE 100 CARY, NC 27518 PHONE: (919) 468-0112 COA: 24GA28099400



REV.	DESCRIPTION	BY	DATE
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B_	REVISED PER COMMENTS	JPB	03/12/21
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ATC SITE NUMBER: 373155

ATC SITE NAME:
PARLIN - SAYREVILLE

AT&T MOBILITY SITE NAME:

PARLIN - NYCWNJ5836

SITE ADDRESS: 775 WASHINGTON ROAD PARLIN. NJ 08859-0000

SEAL:

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	DATE DRAWN:	01/20/21
	ATC JOB NO:	13325346_G2
	CUSTOMER ID:	NWL05836
	CUSTOMER #:	14652316

DETAILED SITE PLAN

SHEET NUMBER:

104


C-101

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GROUND SOW

- INSTALL VERTIV WIC W/ VERTIV 7100 PP, (8) RECTIFIERS, & (0) CONVERTERS

- INSTALL VERTIV WIG WIVERTIV / INSTALL (1) FSM4 AMIA IN FIF INSTALL (1) 5G AMIA IN FIF INSTALL (1) DC12RM IN FIF INSTALL (2) FIBER TRAYS IN FIF INSTALL (2) FMBS AT ICEBRIDGE

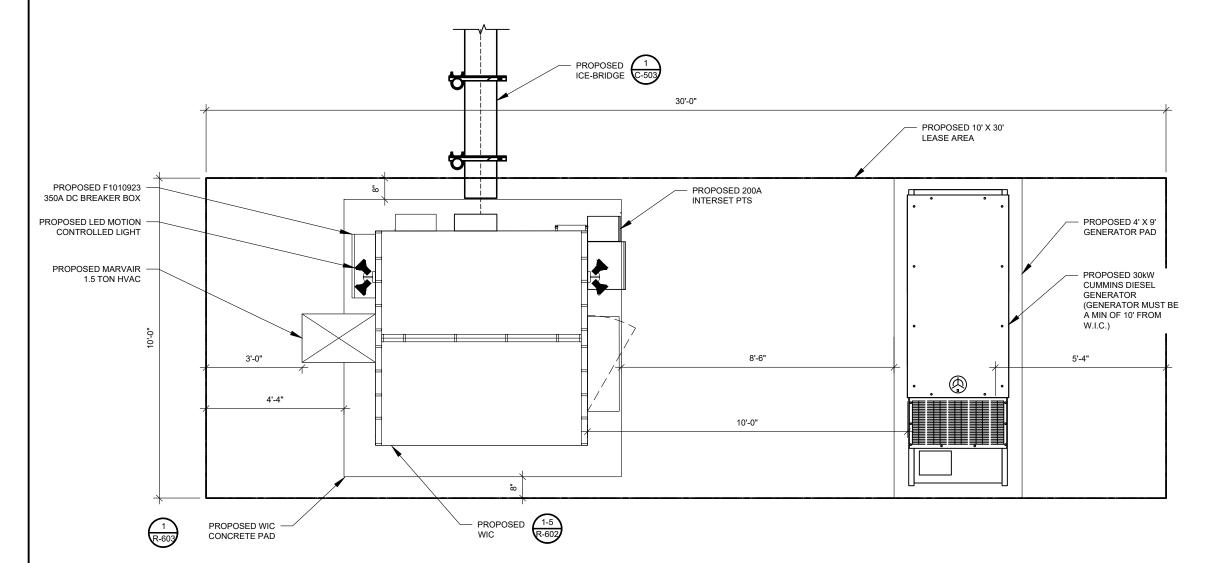

DETAILED EQUIPMENT LAYOUT



ATC TOWER SERVICES, LLC

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SEAL:




	DATE DRAWN:	01/20/21
	ATC JOB NO:	13325346_G2
	CUSTOMER ID:	NWL05836
	CUSTOMER #:	14652316

DETAILED EQUIPMENT LAYOUT

SHEET NUMBER:

C-102

В

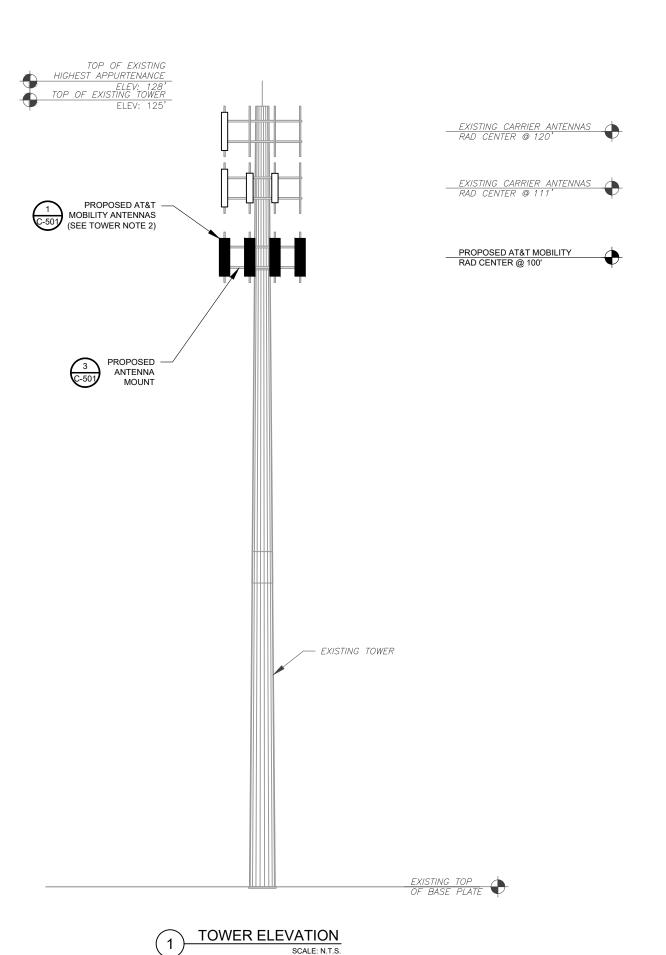

PER MOUNT ANALYSIS COMPLETED BY ESHA MODI, DATED JANUARY 12, 2021, THE EXISTING MOUNT CAN ADEQUATELY SUPPORT THE PROPOSED LOADING

- TOWER NOTE:

 1. IT IS THE CONTRACTOR'S RESPONSIBILITY TO CONFIRM WITH THE PROJECT MANAGER THAT THEY HAVE THE MOST RECENT VERSION OF THE STRUCTURAL ANALYSIS BEFORE COMMENCING WORK. EXISTING AND PROPOSED TOWER APPURTENANCES, MOUNTS, AND ANTENNAS ARE SHOWN BASED ON THE STRUCTURAL ANALYSIS.
- 2. WHERE APPLICABLE, ALL NEW ANTENNAS, EQUIPMENT, MOUNTS, CABLING, ETC. SHALL BE PAINTED/SOCKED TO MATCH EXISTING EQUIPMENT IN ACCORDANCE WITH FAA, JURISDICTION, AND/OR OTHER LOCAL REQUIREMENTS.
- 3. ROUTE PROPOSED CABLES ALONG SAME PATH AS EXISTING CABLES AND IN ACCORDANCE WITH STRUCTURAL ANALYSIS. IF ADEQUATE SPACE EXISTS, ROUTE CABLES THROUGH ENTRY PORT HOLE, UP INSIDE OF MONOPOLE, AND THROUGH EXIT PORT HOLE. IF ROUTING OUTSIDE THE MONOPOLE, ATTACH CABLES USING STAND-OFF ADAPTERS MOUNTED TO TOWER USING STAINLESS STEEL BANDING. ADEQUATELY SECURE CABLES USING EITHER APPROPRIATELY SIZED STAINLESS STEEL SNAP-INS OR MOUNTING HARDWARE AND BRACKETS AS SPECIFIED BY CABLE
- TOWER ELEVATIONS ARE MEASURED FROM TOP OF BASE PLATE TO MATCH STRUCTURAL ANALYSIS. ELEVATIONS DO NOT REFLECT TRUE ABOVE GROUND LEVEL (A.G.L.)



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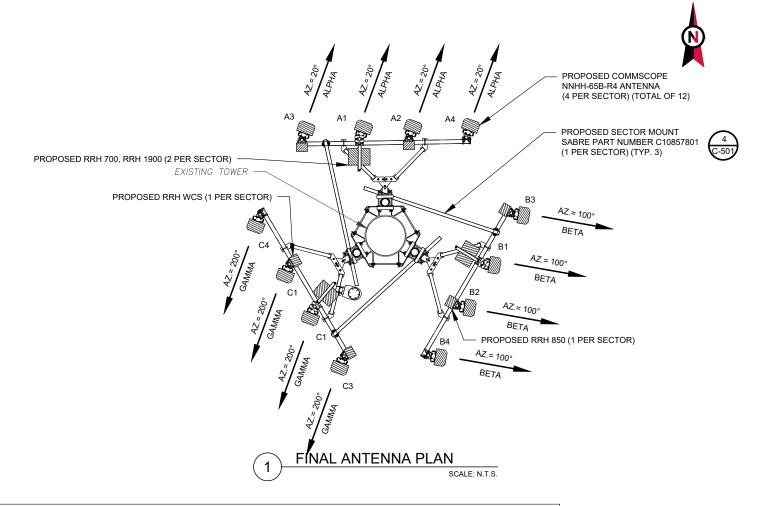


	DATE DRAWN:	01/20/21
	ATC JOB NO:	13325346_G2
	CUSTOMER ID:	NWL05836
	CUSTOMER #:	14652316

DETAILED SITE PLAN & TOWER ELEVATION

SHEET NUMBER:

C-201



					FINAL ANTENNA SCHE	DULE			
LO	CATION			AN	TENNA SUMMARY			NON ANTENNA SUMMA	RY
SECTOR	RAD	AZ	POS	ANTENNA	BAND	MECH/ELEC D-TILT	STATUS	ADDITIONAL TOWER MOUNTED EQUIPMENT	STATUS
			A3	NNHH-65B-R4	RRH-WCS	0	ADD	AIRSCALE RRH 4T4R B30 100W AHNA	ADD
	100'	20°	A1	NNHH-65B-R4	RRH-700, RRH-1900	0	ADD	AIRSCALE TRI RRH 4T4R B12/14/29 370W AHLBBA, AIRSCALE DUAL RRH 4T4R B25 / 66 320W AHFIB	ADD
ALPHA	100	20	A2	NNHH-65B-R4	RRH-850	0	ADD	AIRSCALE RRH 4T4R B5 160W AHCA	ADD
			A4	NNHH-65B-R4	-	0	ADD		-
BETA			В3	NNHH-65B-R4	RRH-WCS	0	ADD	AIRSCALE RRH 4T4R B30 100W AHNA	ADD
	100'	100°	B1	NNHH-65B-R4	RRH-700, RRH-1900	0	ADD	AIRSCALE TRI RRH 4T4R B12/14/29 370W AHLBBA, AIRSCALE DUAL RRH 4T4R B25 / 66 320W AHFIB	ADD
			B2	NNHH-65B-R4	RRH-850	0	ADD	AIRSCALE RRH 4T4R B5 160W AHCA	ADD
			B4	NNHH-65B-R4	-	0	ADD	=	-
			СЗ	NNHH-65B-R4	RRH-WCS	0	ADD	AIRSCALE RRH 4T4R B30 100W AHNA	ADD
GAMMA	100'	200°	C1	NNHH-65B-R4	RRH-700, RRH-1900	0	ADD	AIRSCALE TRI RRH 4T4R B12/14/29 370W AHLBBA, AIRSCALE DUAL RRH 4T4R B25 / 66 320W AHFIB	ADD
			C2	NNHH-65B-R4	RRH-850	0	ADD	AIRSCALE RRH 4T4R B5 160W AHCA	ADD
			C4	NNHH-65B-R4	-	0	ADD	-	-

1. CONFIRM WITH AT&T MOBILITY REP FOR APPLICABLE UPDATES/REVISIONS AND MOST RECENT RFDS FOR NSN CONFIGURATION (CONFIG).

2. CONFIRM SPACING OF PROPOSED EQUIP DOES NOT CAUSE TOWER CONFLICTS NOR IMPEDE TOWER CLIMBING PEGS.

GC TO CAP ALL UNUSED PORTS.

CABLE LENGTHS FOR JUMPERS FIBER DISTRIBUTION/OVP TO RRU: 15' COMBINER TO ANTENNA: 10'

PROPOSED FIBER DISTRIBUTION/OVP BOX PROPOSED CABLING SUMMARY FIBER/DC MODEL NUMBER STATUS STATUS TRUNKS (3) FIBER 24-PAIR ADD ADD 6 AWG 6 ADD (9) DC TRUNKS

ANTENNA SCHEDULE

(5) 2" INNERDUCTS [(3) WITH (1) FIBER & (2) DC TRUNKS, (1) WITH (2) DC TRUNKS, AND (1) WITH (1) DC TRUNK]



ATC TOWER SERVICES, LLC 3500 REGENCY PARKWAY SUITE 100 CARY, NC 27518 PHONE: (919) 468-0112

COA: 24GA28099400



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B	REVISED PER COMMENTS	JPB	03/12/21
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ATC SITE NUMBER: 373155

ATC SITE NAME: PARLIN - SAYREVILLE

AT&T MOBILITY SITE NAME:

PARLIN - NYCWNJ5836

SITE ADDRESS: 775 WASHINGTON ROAD PARLIN, NJ 08859-0000





	DATE DRAWN:	01/20/21
	ATC JOB NO:	13325346_G2
	CUSTOMER ID:	NWL05836
	CUSTOMER #:	14652316

ANTENNA INFORMATION & SCHEDULE

SHEET NUMBER:

REVISION: C-401

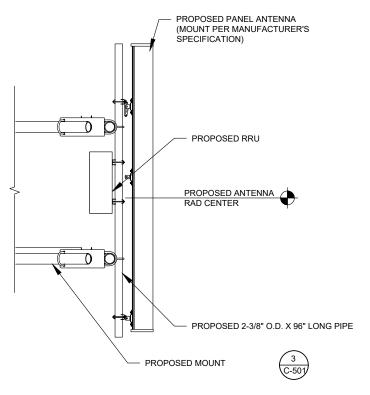


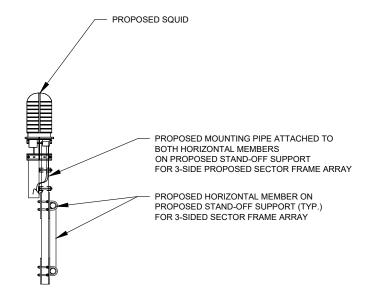

PROPOSED ANTENNA MOUNTING DETAIL (ELEVATION)

SCALE: NOT TO SCALE

PROPOSED OVP MOUNTING
SCALE: NOT TO SCALE

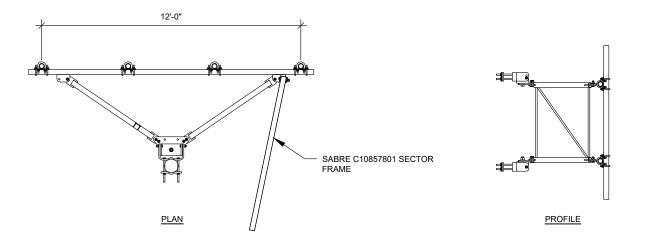

3 SECTOR FRAME DETAIL

SCALE: N.T.S.



ATC TOWER SERVICES, LLC

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PARLIN - SAYREVILLE

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PARLIN - NYCWNJ5836

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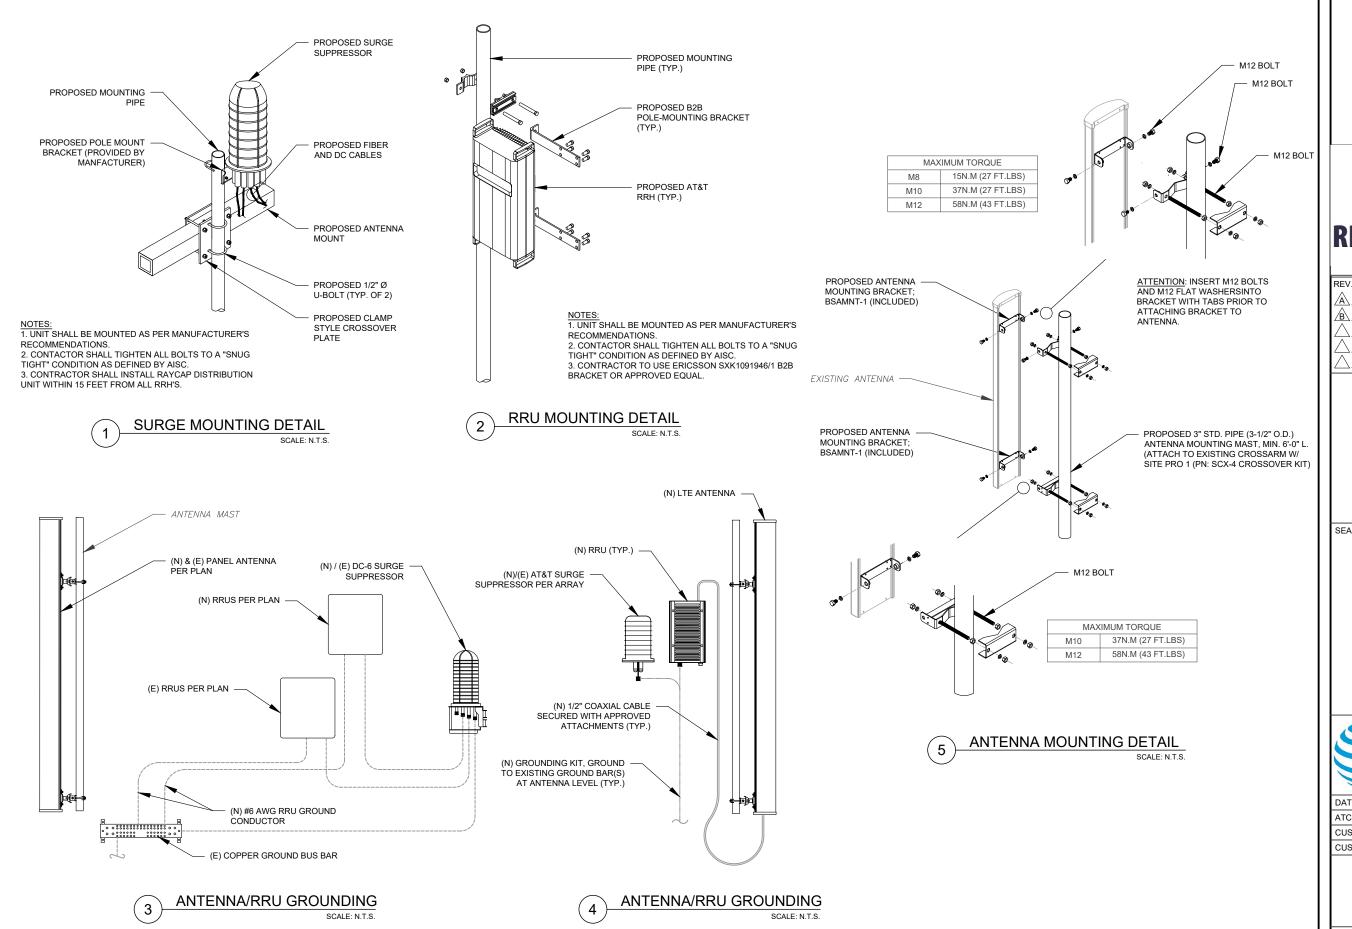
l	DATE DRAWN:	01/20/21
l	ATC JOB NO:	13325346_G2
l	CUSTOMER ID:	NWL05836
l	CUSTOMER #:	14652316

CONSTRUCTION DETAILS

SHEET NUMBER:

C-501

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ATC TOWER SERVICES, LLC

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l	REV.	DESCRIPTION	BY	DATE
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ATC SITE NUMBER: 373155

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AT&T MOBILITY SITE NAME:

PARLIN - NYCWNJ5836

SITE ADDRESS: 775 WASHINGTON ROAD PARLIN, NJ 08859-0000



DATE DRAWN:	01/20/21
ATC JOB NO:	13325346_G2
CUSTOMER ID:	NWL05836
CUSTOMER #:	14652316


CONSTRUCTION **DETAILS**

SHEET NUMBER:

REVISION: C-502

CONSTRUCTION NOTE:


1. INSTALL ICE BRIDGE TO ALLOW 7 FEET CLEARANCE ABOVE GRADE TO LOWEST APPURTENANCE.

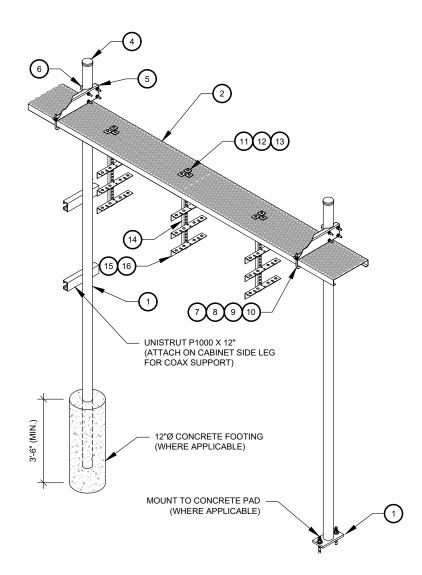

WB-K210-B WAVEGUIDE BRIDGE KIT - BILL OF MATERIALS (INCLUDED WITH KIT UNLESS NOTED OTHERWISE)							
ITEM	PART NUMBER	DESCRIPTION	ITEM	PART NUMBER	DESCRIPTION		
1	MF126.01 MF-130	10'-4" COLUMN & BASE SHOE* 13'-4" PIPE COLUMN	9	GWL-04	1/2" GALV LOCK WASHER		
2	WB-CY210	SAFETY GRATING 24" X 10'	10	GN-04	1/2" GALV HEX NUT		
3	WBK110BHK	HARDWARE KIT (ITEMS 4-16)	11	GB-03205	3/8" X 2" GALV BOLT KIT		
4	PC-034	PIPE CAP 3-1/2"	12	MT-387	SQUARE WASHER, 1-1/2" X 1-1/2" W/ 7/16" HOLE		
5	WBLB243.08	24" WAVEGUIDE BRIDGE SUPPORT BRACKET	13	GWF-03	3/8" GALV FLAT WASHER		
6	GUB-4356	1/2" X 3-5/8" X 6" GALV U-BOLT	14	WBT243.01	VERTICAL TRAPEZE SECTION		
7	WB-JB-6	1/2" J-BOLT	15	GB-03105	3/8" X 1" GALV BOLT KIT		
8	GWF-04	1/2" GALV FLAT WASHER	16	WBT243.02	HORIZONTAL TRAPEZE SECTION		


CONTRACTOR SHALL USE PARTS MANUFACTURED BY COMMSCOPE OR APPROVED EQUIVALENT. *BASE SHOE NOT INCLUDED IN WB-K210-B KIT, ORDER COLUMN SEPARATELY OR KIT WB-K210-S.

> WAVEGUIDE BRIDGE KIT SCALE: NOT TO SCALE

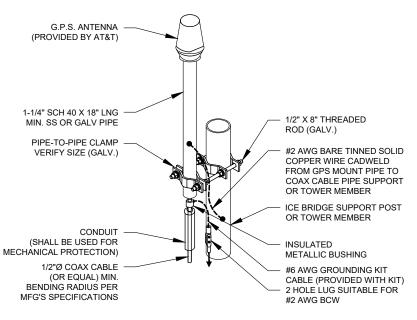

- GPS SHALL BE PLACED WITH CLEAR SIGHT LINE TO THE SOUTHERN SKY.
- CONTRACTOR TO SUPPLY COAX FOR GPS UNIT.



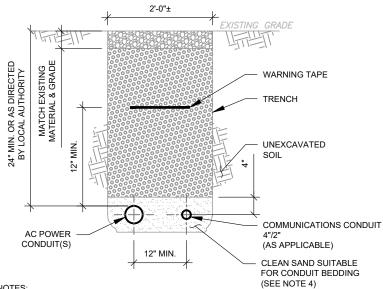

TRENCH NOTES:

- IF FREE OF ORGANIC OR OTHER DELETERIOUS MATERIAL, EXCAVATED MATERIAL MAY BE USED FOR BACKFILL. IF NOT, PROVIDE CLEAN, COMPACTIBLE MATERIAL.
 COMPACT IN 8" LIFTS. REMOVE ANY LARGE ROCKS PRIOR TO BACKFILLING. CONTRACTOR
- TO VERIFY LOCATION OF EXISTING U/G UTILITIES PRIOR TO DIGGING.
- IF CURRENT AS-BUILT DRAWINGS ARE NOT AVAILABLE CONTRACTOR SHALL HAND DIG
- USE COMMUNICATIONS ONLY TRENCH FOR COMMUNICATIONS CONDUIT UNLESS TRAVELING UNDER PATH OF VEHICLE TRAVEL, THEN CONDUIT MUST BE 24" MIN. BELOW GRADE
- CONFIRM SPACING AND DEPTH WITH NEC OR LOCAL CODE REQUIREMENTS

POWER/TELCO CONDUIT TRENCH DETAILS



ATC TOWER SERVICES, LLC

3500 REGENCY PARKWAY SUITE 100 **CARY, NC 27518** PHONE: (919) 468-0112 COA: 24GA28099400



REV.	DESCRIPTION	BY	DATE
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ATC SITE NUMBER: 373155

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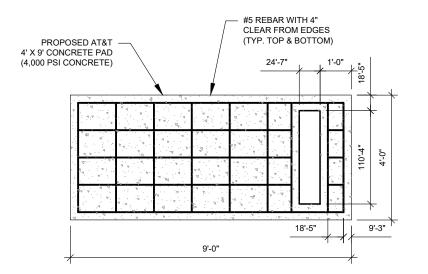



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П	DATE DRAWN:	01/20/21
П	ATC JOB NO:	13325346_G2
П	CUSTOMER ID:	NWL05836
П	CUSTOMER #:	14652316

CONSTRUCTION **DETAILS**


SHEET NUMBER:

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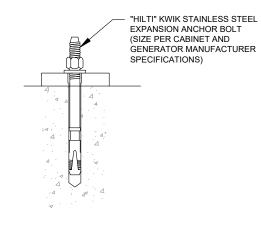


CONCRETE GENERATOR PAD DESIGN

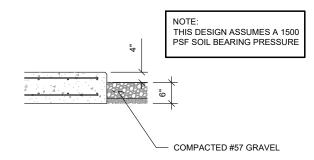


PAD NOTES:

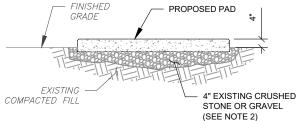
- 1. SUBGRADE AND FILL SHALL CONSIST OF CLEAN SOIL. DELETRIOUS MATERIAL AND ORGANICS SHALL BE REMOVED.
- 2. MECHANICALLY COMPACT FOOTPRINT OF PAD PLUS 2' PERIMETER.
- USE GALVANIZED HILTI EXPANSION ANCHORS OR, APPROVED EQUAL, FOR EQUIPMENT ANCHORAGE.
- 4. FOR SIZE AND LOCATION OF ANCHORS AND OTHER REQUIREMENT, SEE EQUIPMENT VENDOR DRAWINGS.



EXPANSION ANCHOR DETAIL

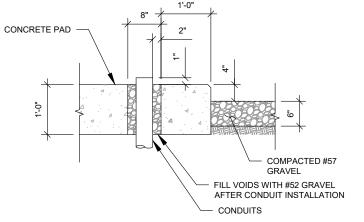

GENERATOR CONDUIT STUB UP DETAIL

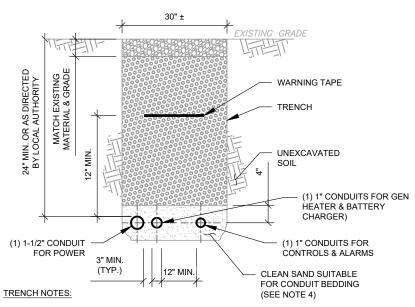

- IF FREE OF ORGANIC OR OTHER DELETERIOUS MATERIAL, EXCAVATED MATERIAL MAY BE USED FOR BACKFILL. IF NOT, PROVIDE CLEAN, COMPACTIBLE MATERIAL.
- COMPACT IN 8" LIFTS. REMOVE ANY LARGE ROCKS PRIOR TO BACKFILLING.
- CONTRACTOR TO VERIFY LOCATION OF EXISTING U/G UTILITIES PRIOR TO DIGGING. IF CURRENT AS-BUILT DRAWINGS ARE NOT AVAILABLE CONTRACTOR SHALL HAND DIG
- USE COMMUNICATIONS ONLY TRENCH FOR COMMUNICATIONS CONDUIT UNLESS TRAVELING UNDER PATH OF VEHICLE TRAVEL, THEN CONDUIT MUST BE 24" MIN.
- CONFIRM SPACING AND DEPTH WITH NEC OR LOCAL CODE REQUIREMENTS

GENERATOR CONDUIT TRENCH DETAILS



3500 REGENCY PARKWAY SUITE 100 **CARY, NC 27518** PHONE: (919) 468-0112 COA: 24GA28099400



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CUSTOMER #:	14652316

CONSTRUCTION **DETAILS**

SHEET NUMBER:

C-504

REVISION:

GRAVEL PREPARATION SCALE: NOT TO SCALE

5



Diesel generator set

25 kW - 40 kW **EPA** emissions stationary Standby



Cummins® generator sets are fully integrated power generation systems providing optimum performance, reliability and versatility for stationary Standby applications.

Cummins heavy-duty engine - Rugged 4-cycle, liquid-cooled, industrial diesel engine delivers reliable power, low emissions and fast response to load changes.

Alternator - Several alternator sizes offer selectable motor starting capability with low reactance 2/3 pitch windings, low waveform distortion with non-linear loads and fault clearing short-circuit capability.

Control system - The PowerCommand® 1.1 electronic control is standard equipment and provides total generator set system integration including automatic remote starting/stopping, precise frequency and voltage regulation, aliam and status message display, output metering, auto-shutdown at fault detection and NFPA 110 Level 1 compliance.

Free The generator set accepts full rated load in a single step in accordance with NFPA 110 for Level 1 systems.

Warranty and service - Backed by a



Cooling system - Standard cooling package provides reliable running at up to 50 ℃ (122 ℉) ambient temperature.

Enclosures - The aesthetically appealing Enclosures - The aesthetically appealing enclosure incorporates special designs that deliver one of the quietest generators of its kind. Aluminum material plus durable powder coat paint provides the best anti-corrosion performance. The generator set enclosure has been evaluated to withstand 180 MPH wind loads in accordance with ASCE7-10. The intelligent design has removable panels and service doors to provide easy access for service and maintenance.

Fuel tanks - Two dual wall sub-base fuel tank series are offered as optional features, providing economical and flexible solutions to meet extensive code requirements on diesel fuel

Warranty and service - Backed by a comprehensive warranty and worldwide distributor network.

		y rating Hz		e rating) Hz	Data sheets 60 Hz	
Model	kW	kVA	kW	kVA		
C25 D6	25	31.3	22.7	28.4	NAD-5860	
C30 D6	30	37.5	27	33.8	NAD-5861	
C35 D6	35	43.8	32	40	NAD-5862	
C40 D6	40	50	36	45	NAD-5863	

Our energy working for you.**

Generator set specifications

Governor regulation class	ISO8528 Part 1 Class G2
Voltage regulation, no load to full load	±1.0%
Random voltage variation	± 0.5% - 3 Phase only
Frequency regulation	Isochronous
Random frequency variation	±0.5%
Radio frequency emissions compliance	FCC code Title 47 Part 15 Class B

ingine specifications	
ore	95.0 mm (3.74 in.)
troke	115.1 mm (4.53 in.)
isplacement	3.3 litres (199 in ³)
onfiguration	Cast iron, in-line, 4 cylinder
attery capacity	550 amps at ambient temperature of 0 °F to 32 °F (-18 °C to 0 °C)
attery charging alternator	40 amps
tarting voltage	12 volt, negative ground
uel system	Indirect injection, number 2 diesel fuel, fuel filter, electric fuel shut off
uel filter	Single element, 10 micron filtration, spin-on fuel filter with water separator
ir cleaner type	Dry replaceable element
ube oil filter type(s)	Spin-on, full flow
tandard cooling system	50 °C (122 °F) ambient cooling system

Alternator specifications	
Design	Brushless, 4 pole, drip proof, revolving field
Stator	2/3 pitch
Rotor	Direct coupled, flexible disc
Insulation system	Class H per NEMA MG1-1.65
Standard temperature rise	120 °C (248 °F) Standby
Exciter type	Torque match (shunt) with PMG/EBS as option
Alternator cooling	Direct drive centrifugal blower
AC waveform Total Harmonic Distortion (THDV)	< 5% no load to full linear load, < 3% for any single harmonic
Telephone Influence Factor (TIF)	< 50 per NEMA MG1-22.43
Telephone Harmonic Factor (THF)	0.03

Available voltages

Single phase	3 phase				
• 120/240	• 120/208	 120/240 delta 	• 277/480	• 347/600	
Note: Consult factor	y for other voltage				

Generator set options

sy	ster	n					
sic	fuel	ta	nks				

- Basic fuel tanks
 Regional fuel tanks
- Engline

 Engline air cleaner normal or heavy duty

 Shut down low oil pressure

 Extension oil drain

 Alternator

 120 °C (248 °F) temperature rise alternator

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 alternator
 105 °C (221 °F) temperature rise alternator

Excitation Boost System (EBS) or PMG Alternator heater, 120 V

Control AC output analog meters (bargraph) Slop switch – emergency Auxillary output relays (2) Auxillary configurable signal inputs (8) and relay outputs (8) Electrical Single circuit breakers Dual circuit breakers Both, rated circuit breakers 100% rated circuit breakers 100% rated circuit breakers Fondourre Cooling system Shutdown – low coolant level Warning – low coolant level Extension – coolant drain Cold weather option for operating at ≼ 1°C (40 °F) Exhaust system Exhaust connector - NPT Open set with muffler mounted Generator set application Battery rack, larger battery Radiator outlet duct adapter

Cooling system

- Warranty
 Base warranty 2 year, 1000 hour, standby, 3 year, 2500 hour, parts and labor
 Standby, 3 year, 1500 hour, parts
 and labor
- Generator set accessories
- Extreme cold weather kit
 Battery rack, larger battery
 Battery heater kit
 HMI211RS in-home display,
- Hilliam Tras in the library including pre-configured 12" harness
 HMI211 remote display, including pre-configured 12" harness
 HMI220 remote display
 Auxiliary output relays (2)

- Battery charger stand-alone, 12 V
 Circuit breakers
 Enclosure Sound Level 1 to Sound Level 2
- Enclosure Sound Level 1 to Sound Level 2 upgrade kit
 Enclosure paint touch up kit
 Enclosure paint touch up kit
 Mufflera industrial, residential or critical
 Alternator Excitation Boost System (EBS)
 If PMG
 PMG
 PMG
 PMG
 PMG
 Enclosure Sound
 Microsure Sound
 Memory
 M

AC protection

Overspeed shutdowr

· Fail to crank shutdown

Sensor failure indication

Cranking lockout

Lube oil pressur

Redundant start disconnect

Over current warning and shutdown
Over and under voltage shutdown
Over and under frequency shutdown
Over excitation (loss of sensing) fault

. Low oil pressure warning and shutdown

Low fuel level warning or shutdown
 Alternator data
 Line-to-Line and Line-to-Neutral AC volts
 3-phase AC current

High coolant temperature warning and shutdown

Control system PowerCon



PowerCommand control is an integrated generator set control system providing voltage regulation, engine protection, operator interface and isochronous governing (optional). Major leatures include:

- reatures include:

 Battery monitoring and testing features and smart starting control system.

 Standard PCCNet interface to devices such as remote annunciator for NFPA 110 applications.

 Control bands potted for environmental protection.

 Control satisface potted for environmental protection.

 Control suitable for operation in ambient temperatures from -40 °C to +70 °C (+40 °F to +158 °F) and altitudes to 5000 meters (13,000 feet).

- Prototype tested; UL, CSA, and CE compliant.
- InPower™ PC-based service tool available for detailed

Operator/display panel Manual off switch

- Alpha-numeric display with pushbutton access for viewing engine and alternator data and providing setup, controls and adjustments (English or international symbols)

 Total kVa Engine data adjustments (English or international symbols)
- LED lamps indicating generator set running, not in auto, common warning, common shutdown, manual run mode and remote start
- Suitable for operation in ambient temperatures from -40 ℃ to +70 ℃
- Bargraph display (optional)

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- Other data . Generator set model data
- Generator set model data
 Start attempts, starts, running hours
 Fault history
 RS485 Modbus® interface
 Data logging and fault simulation (rec service tool)

- service tool)
 Digital governing (optional)
 Integrated digital electronic isochronous gove
 Temperature dynamic governing
 Digital voltage regulation
 Integrated digital electronic voltage regulator
- · 2-phase Line-to-Line sensing · Configurable torque matching
- Control functions
- . Time delay start and cooldown

- (2) Configurable outputs
- Remote emergency stop
 Automatic Transfer Switch (ATS) control

Ratings definitions

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(COP) in accordance with ISO 8528, ISO 3046, AS 2789, number DIN 6271 and BS 5514.

- Options
 Auxiliary output relays (2)
- Remote annunciator with (3) configurable inputs and (4) configurable outputs PMG alternator excitation
- PowerCommand 500/550 for remote monitoring and alarm notification (accessory)
- Auxiliary, configurable signal inputs (8) and configurable relay outputs (8) Digital governing
 AC output analog meters (bargraph)
 - Color-coded graphical display of:
 3-phase AC voltage
 - 3-phase current - Frequency
- · Remote operator pane

· Generator set exercise, field adjustable

Emergency Standby Power (ESP): Applicable for supplying power to varying electrical load for the duration of power interruption of a reliable utility source. Emergency Standby Power (ESP) is in accordance with ISO 8528. Fuel Stop power in accordance with ISO 3046, AS 2789, DIN 6271 and BS 5514.

Limited-Time Running Power (LTP):
Applicable for supplying power to a constant electr
load for limited hours. Limited-Time Running Power
(LTP) is in accordance with ISO 8528.

(LTP) is in accordance with ISO 5528.

Prime Power (PRP):
Applicable for supplying power to varying electrical load for unlimited hours. Prime Power (PRP) is in accordance with ISO 8528. Ten percent overload capability is available in accordance with ISO 3046, AS 2789, DIN 6271 and BS 5514.

Do not use for installation design

	l ==	n	n		
Model	Dim "A" mm (in.)	Dim "B" mm (in.)	Dim "C" mm (in.)	Set weight* dry kg (lbs)	Set weight* wet kg (lbs)
	. , ,	Open	set		
C25 D6	2224 (87.5)	864 (34)	1121 (44.13)	504 (1115)	525 (1161)
C30 D6	2224 (87.5)	864 (34)	1121 (44.13)	533 (1178)	553 (1224)
C35 D6	2224 (87.5)	864 (34)	1121 (44.13)	552 (1221)	573 (1267)
C40 D6	2224 (87.5)	864 (34)	1121 (44.13)	566 (1252)	587 (1298)
	So	und attenuated e	nclosure Level 1		
C25 D6	2384 (93.8)	864 (34)	1156 (45.5)	551 (1219)	572 (1265)
C30 D6	2384 (93.8)	864 (34)	1156 (45.5)	580 (1282)	600 (1328)
C35 D6	2384 (93.8)	864 (34)	1156 (45.5)	599 (1325)	620 (1371)
C40 D6	2384 (93.8)	864 (34)	1156 (45.5)	613 (1356)	634 (1402)
	So	und attenuated e	nclosure Level 2		
C25 D6	2629 (103.5)	864 (34)	1156 (45.5)	570 (1261)	591 (1307)
C30 D6	2629 (103.5)	864 (34)	1156 (45.5)	599 (1324)	619 (1370)
C35 D6	2629 (103.5)	864 (34)	1156 (45.5)	618 (1367)	639 (1413)
C40 D6	2629 (103.5)	864 (34)	1156 (45.5)	632 (1398)	653 (1444)

Weights represent a set with standard features. See outline drawings for weights of other configurations.

Codes and standards

Codes of staridards comp	marice may not be available with a	i iliodei colligurations – co	ribuit factory for availability.
150 9001	This generator set is designed in facilities certified to ISO 9001 and manufactured in facilities certified to ISO 9001 or ISO 9002.	(UL)	The generator set is available Listed to UL 2200, Stationary Engine Generator Assemblies.
	The Prototype Test Support (PTS) program verifies the performance integrity of the generator set design. Cummins products bearing the PTS symbol meet the prototype test requirements of NFPA 110 for Level 1 systems.	U.S. EPA	Engine certified to U.S. EPA SI Stationary Emission Regulation 40 CFR, Part 60.
(1)	All low voltage models are CSA certified to product class 4215-01.	International Building	The generator set is certified for seismic application in accordance with International

Warning: Back feed to a utility system can cause electrocution and/or property damage. Do not connect to any building's electrical system except through an approved device or after building main switch is open.

For more information contact your local Cummins distributor or visit power.cummins.com

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ATC TOWER SERVICES, LLC

3500 REGENCY PARKWAY SUITE 100 **CARY, NC 27518** PHONE: (919) 468-0112 COA: 24GA28099400



REV. DESCRIPTION BY DATE **PRELIM** RW 01/25/21

> ATC SITE NUMBER: 373155

ATC SITE NAME: PARLIN - SAYREVILLE

AT&T MOBILITY SITE NAME:

PARLIN - NYCWNJ5836 SITE ADDRESS: 775 WASHINGTON ROAD PARLIN. NJ 08859-0000

SEAL:



CUSTOMER #: 14652316 **GENERATOR**

SPECIFICATIONS

13325346 G2


SHEET NUMBER:

DATE DRAWN: 01/20/21

CUSTOMER ID: NWL05836

ATC JOB NO:

C-505

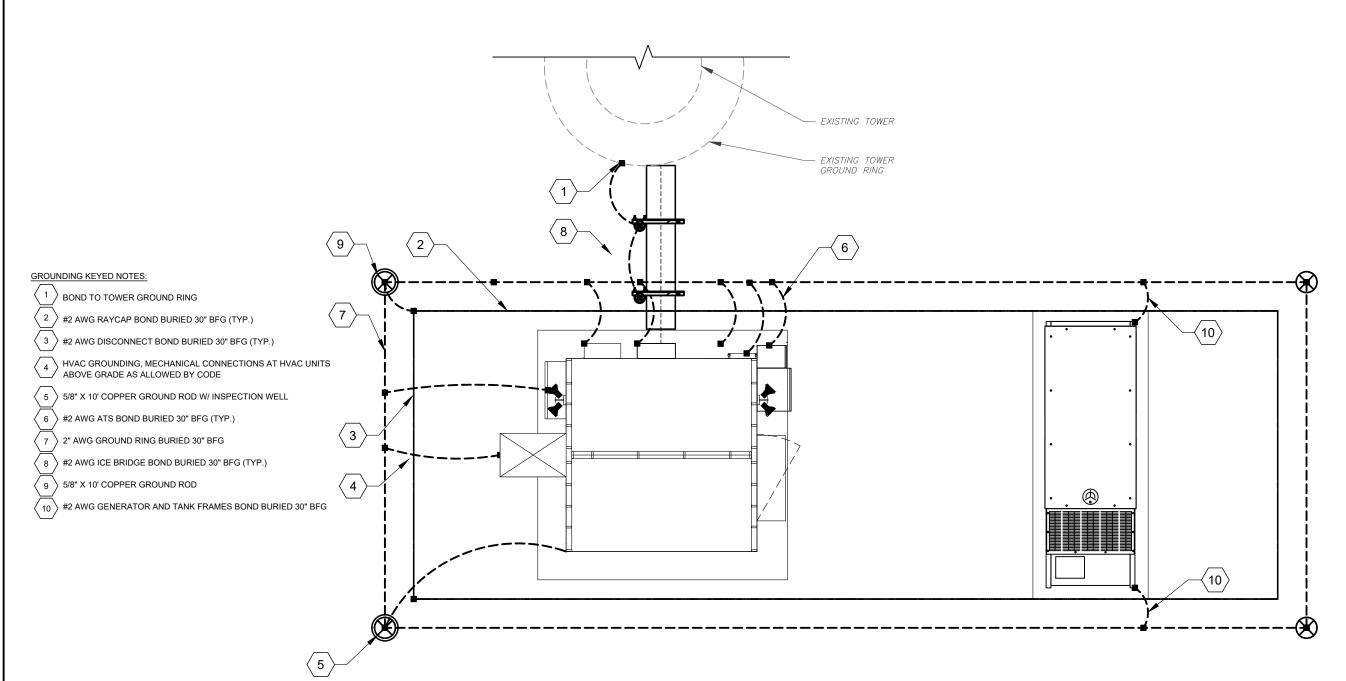

1 DETAILED GROUNDING LAYOUT SCALE: NOT TO SCALE



ATC TOWER SERVICES, LLC

3500 REGENCY PARKWAY SUITE 100 CARY, NC 27518 PHONE: (919) 468-0112 COA: 24GA28099400



REV.	DESCRIPTION	BY	DATE
A_	PRELIM	RW	01/25/21
B_	REVISED PER COMMENTS	JPB	03/12/21
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ATC SITE NUMBER: 373155

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PARLIN - SAYREVILLE

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PARLIN - NYCWNJ5836

SITE ADDRESS: 775 WASHINGTON ROAD PARLIN, NJ 08859-0000

SEAL:

C:UsersijbaptistalDocumentalNambrus NJ Seal_w Signature.jp



	DATE DRAWN:	01/20/21
	ATC JOB NO:	13325346_G2
	CUSTOMER ID:	NWL05836
	CUSTOMER #:	14652316


GROUNDING PLAN

SHEET NUMBER:

E-101

REVISION:

В

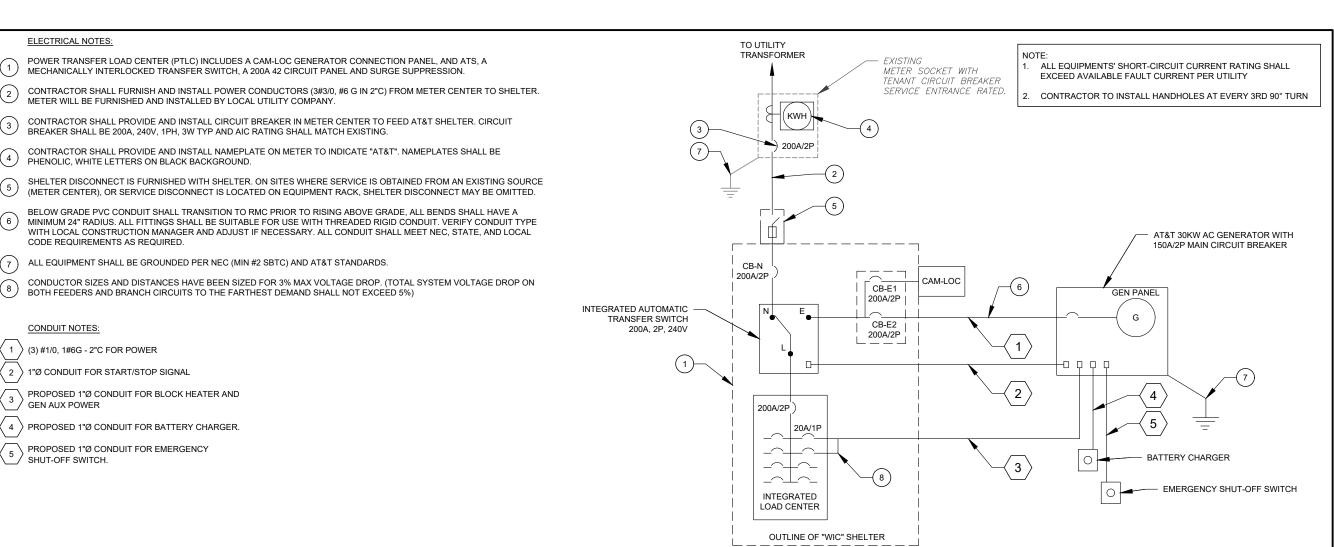

PANEL			_				120/240V, 3W, 42 CKT		LOCATION:	AT&T LEASE	AREA				
ESIGN	ATION: _	AT&T	MOUNTING: _	SURFAC	=	-	MAIN BE		• •	200A		_			
			ENCLOSURE_				MAIN BU	JS RATIN	NG:	200A		PANEL NOTES:	WIC INTEGRAT	ED PANE	L
			_			-	MIN. A.I	.C. RATII	NG:	65K		_			
CONNE	CTED		F	EEDER OR BRA	NCH CIRC	UIT	UIT FEEDER OR BRANCH CIR			CIRCUIT			CONNECTED		
LOAD	(kVA)	BRIEF DESCRIPTION		BREAKER	POLE	CIRC.	i	CIRC.	POLE	BREAKER		BRIEF DI	ESCRIPTION	LOAD) (kVA
A B			AMP	S POLES	POLE		I I	NOTES		POLES AMPS				АВ	
2.00					1	NOTES			2	1	20	EXT. GFO	CLOUTLETS	0.18	<u> </u>
	2.00	RECTIFIER #1	30	2	3				4	_					2.00
2.00					5				6	2	30	RECTIFIER #2		2.00	
	2.00	RECTIFIER #3	30	2	7				8	_		2507	TEIED #4		2.0
2.00		RECTIFIER #5	20		9				10	2	30	RECTIFIER #4		2.00	
	2.00	RECTIFIER #5	30	2	11				12	2	30	DECT	TFIER #6		2.0
0.00		SPACE			13				14	2	30	RECT	IFIER #6	2.00	
	0.00	SPACE			15				16			SI	PACE		0.0
0.68		SPACE			17				18			SI	PACE	0.00	
	0.00	SPACE			19				20			SI	PACE		0.0
00.C		SPACE			21				22			SI	PACE	0.00	
	0.00	SPACE			23				24			SI	PACE		0.0
3.50		1.5 TON AC UNIT	20	2	25				26			SI	PACE	0.00	
	3.50	1.5 TON AC ONIT	20		27				28	1	20	GFI REC	EPT / LIGHT		0.7
0.48		FIBER BOX OUTLET	20	1	29				30	1	20		CK HEATER	1.92	
	0.00	SPACE			31				32	1	20		Y CHARGER		1.9
0.00		SPACE			33				34				PACE	0.00	
	0.00	SPACE			35				36				PACE		0.0
0.00		SPACE			39				40				PACE	0.00	
	0.00	SPACE			41				42			SI	PACE		0.0
10.7	9.5					Α	В	тот						8.1	8.6
						18.8	18.1	36.		CONNECTED LC					
						18.8	18.1	36.	.9	DEMAND LOAD	(kVA)		ATING FACTOR (80% EMANDLOAD SIZING		AMP

NOTES:

1. ALL CONDUCTORS ARE TYPE THWN (75°C) COPPER.

2. MAXIMUM LENGTH OF RUN FOR RECTIFIER CIRCUITS IS 50 FT.



ELECTRICAL ONE-LINE DIAGRAM





l	REV.	DESCRIPTION	BY	DATE
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ATC SITE NUMBER: 373155

ATC SITE NAME:
PARLIN - SAYREVILLE

AT&T MOBILITY SITE NAME:

PARLIN - NYCWNJ5836

SITE ADDRESS: 775 WASHINGTON ROAD PARLIN. NJ 08859-0000

SEAL:

ersijbaptista/Documents/Nambrus NJ Seal_w Signature.jpg




DATE DRAWN: 01/20/21
ATC JOB NO: 13325346_G2
CUSTOMER ID: NWL05836
CUSTOMER #: 14652316

ELECTRICAL ONE-LINE & PANEL SCHEDULE


SHEET NUMBER:

E-102

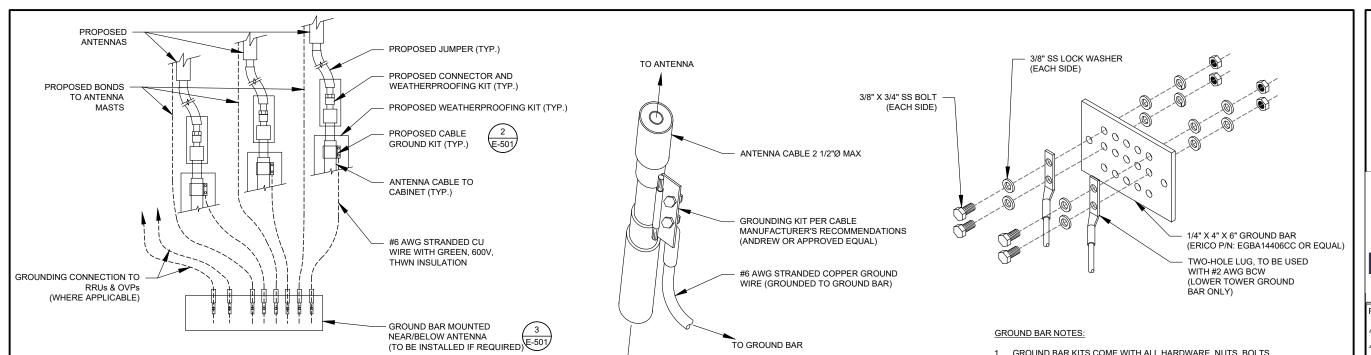

- THIS DETAIL IS INTENDED TO SHOW THE GENERAL GROUNDING REQUIREMENTS. SLIGHT ADJUSTMENTS MAY BE REQUIRED BASED ON EXISTING SITE CONDITIONS. THE CONTRACTOR SHALL MAKE FIELD ADJUSTMENTS AS NEEDED AND INFORM THE CONSTRUCTION MANAGER OF ANY CONFLICTS.
- 2. SITE GROUNDING SHALL COMPLY WITH AT&T GROUNDING STANDARDS, LATEST EDITION, AND COMPLY WITH AT&T GROUNDING CHECKLIST, LATEST VERSION. WHEN NATIONAL AND LOCAL GROUNDING CODES ARE MORE STRINGENT THEY SHALL GOVERN.

TYPICAL ANTENNA GROUNDING DIAGRAM

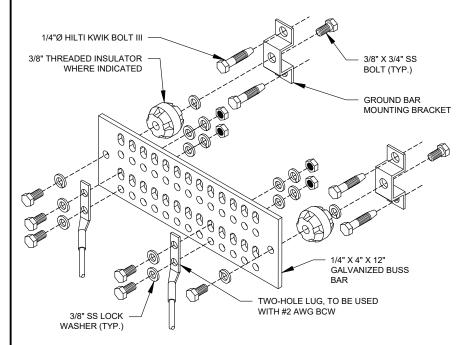

GROUND BAR NOTES

- GROUND KITS COME WITH ALL HARDWARE, NUTS, BOLTS, WASHERS, ETC. EXCEPT THE STRUCTURAL MOUNTING MEMBER(S).
- 2. GROUND BAR SHALL BE BOLTED TO STRUCTURAL MEMBER OR ANCHORED TO CONCRETE SLAB W/ HILTI KWIK BOLT III.

TO EQUIPMENT


- GROUND KIT NOTES:


 1. DO NOT INSTALL CABLE GROUND KIT AT A BEND AND ALWAYS DIRECT GROUND WIRE DOWN TO GROUND BAR.
- 2. CONTRACTOR SHALL PROVIDE WEATHERPROOFING KIT (ANDREW PART NUMBER 221213) AND INSTALL/TAPE PER MANUFACTURER'S SPECIFICATIONS

CABLE GROUND KIT CONNECTION DETAIL

NOTES:

- SEPARATION DIMENSION TO BE VERIFIED WITH LOCAL UTILITY COMPANY
- 2. COORDINATE UTILITY, LOCATE BEFORE DIGGING.
- CONDUIT TRENCHING DEPTHS AT 36" OR 6" BELOW FROST LINE, WHICHEVER IS GREATER.
- ALL RING AND RADIAL DEPTHS AT 30" OR 6" BELOW FROST LINE, WHICHEVER IS GREATER.

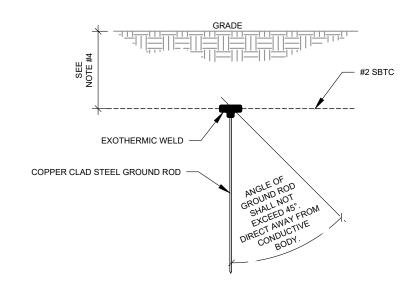

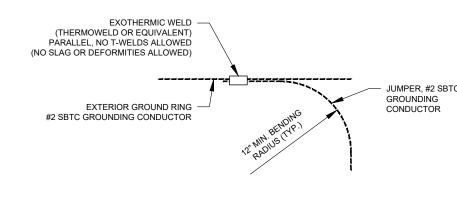

GROUND ROD DETAIL

TIE CONNECTION DETAIL

- GROUND BAR KITS COME WITH ALL HARDWARE, NUTS, BOLTS, WASHERS, ETC. EXCEPT THE STRUCTURAL MOUNTING MEMBER(S).
- 2. GROUND BAR TO BE BONDED DIRECTLY TO TOWER.

TOWER GROUND BAR DETAIL

SCALE: NOT TO SCALE



AMERICAN TOWER

ATC TOWER SERVICES, LLC

3500 REGENCY PARKWAY SUITE 100

CARY, NC 27518

PHONE: (919) 468-0112

COA: 24GA28099400

DESCRIPTION

ATC SITE NUMBER: 373155

ATC SITE NAME:

PARLIN - SAYREVILLE

AT&T MOBILITY SITE NAME:

PARLIN - NYCWNJ5836 SITE ADDRESS: 775 WASHINGTON ROAD

BY DATE



GROUNDING DETAILS

SHEET NUMBER:


E-501

REVISION



MAIN GROUND BAR DETAIL

SCALE: NOT TO SCALE

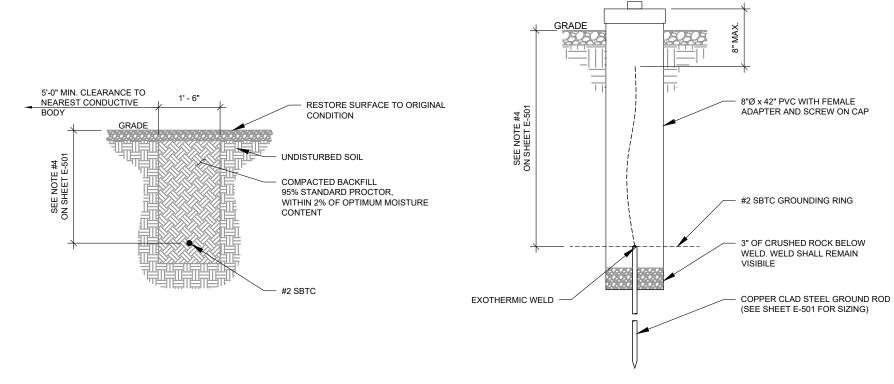


1 GROUND CONNECTION TRENCH DETAIL (STD.)

SCALE: NOT TO SCALE

2 TEST WELL DETAIL

SCALE: NOT TO SCALE

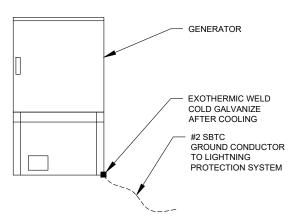

GENERATOR INSTALLATION NOTE:

INSTALL GENERATOR AND TRANSFER SWITCH WITH ALL SUPPLIED ACCESSORIES PER MANUFACTURER'S INSTALLATION INSTRUCTIONS AND SPECIFICATIONS. THIS INCLUDES, BUT IS NOT LIMITED TO, ACCESSORIES FOR THE EXHAUST SYSTEM, FUEL SYSTEM, ENCLOSURE INTEGRITY (CAPS, PLUGS, COVERS, ETC.), ELECTRICAL CONNECTIONS, AND GROUNDING CONNECTIONS.





ATC TOWER SERVICES, LLC

3500 REGENCY PARKWAY SUITE 100 CARY, NC 27518 PHONE: (919) 468-0112 COA: 24GA28099400



ı	REV	. DESCRIPTION	BY	DATE
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ATC SITE NUMBER: 373155

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SEA

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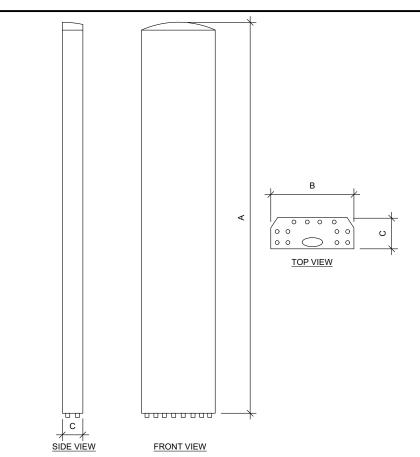
	DATE DRAWN:	01/20/21
	ATC JOB NO:	13325346_G2
	CUSTOMER ID:	NWL05836
	CUSTOMER #:	14652316

GROUNDING DETAILS

SHEET NUMBER:


E-502

Α




ANTENNA SPECIFICATIONS				
ANTENNA MODEL	А	В	С	WEIGHT (LBS)
COMMSCOPE NNHH-65B-R4	72"	19.6"	7.8"	78.3


1 ANTENNA SPECIFICATIONS
NOT TO SCALE

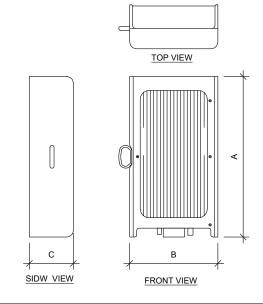


	RRU SPEC	IFICATI	IONS		
RRU MODEL	-	А	В	С	WEIGHT (LBS)
AIRSCALE TRI RRH 4T4R B12/14/29 370W AHLBBA		-	-	=	=
AIRSCALE DUAL RRH 66 320W AHF		22"	12.1"	5.9"	66.1
AIRSCALE RRH 4T4R AHCA	B5 160W 1	3.3"	11.6"	6.5"	35.3
AIRSCALE RRH 4T4R B30 100W AHNA		3.3"	12.1"	5.5"	34.2

2 RRU SPECIFICATIONS
NOT TO SCALE

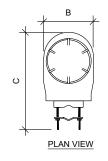

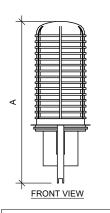

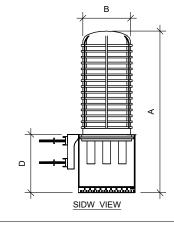

RAYCAP SPECIFICATIONS					
RAYCAP MODEL	А	В	С	D	WEIGHT (LBS)
DC9-48-60-24-8C-EV	31.4"	10.2	18.3"	-	16


RAYCAP SPECIFICATIONS
NOT TO SCALE

SUPPLEMENTAL


SHEET NUMBER:

REVISION:

R-601

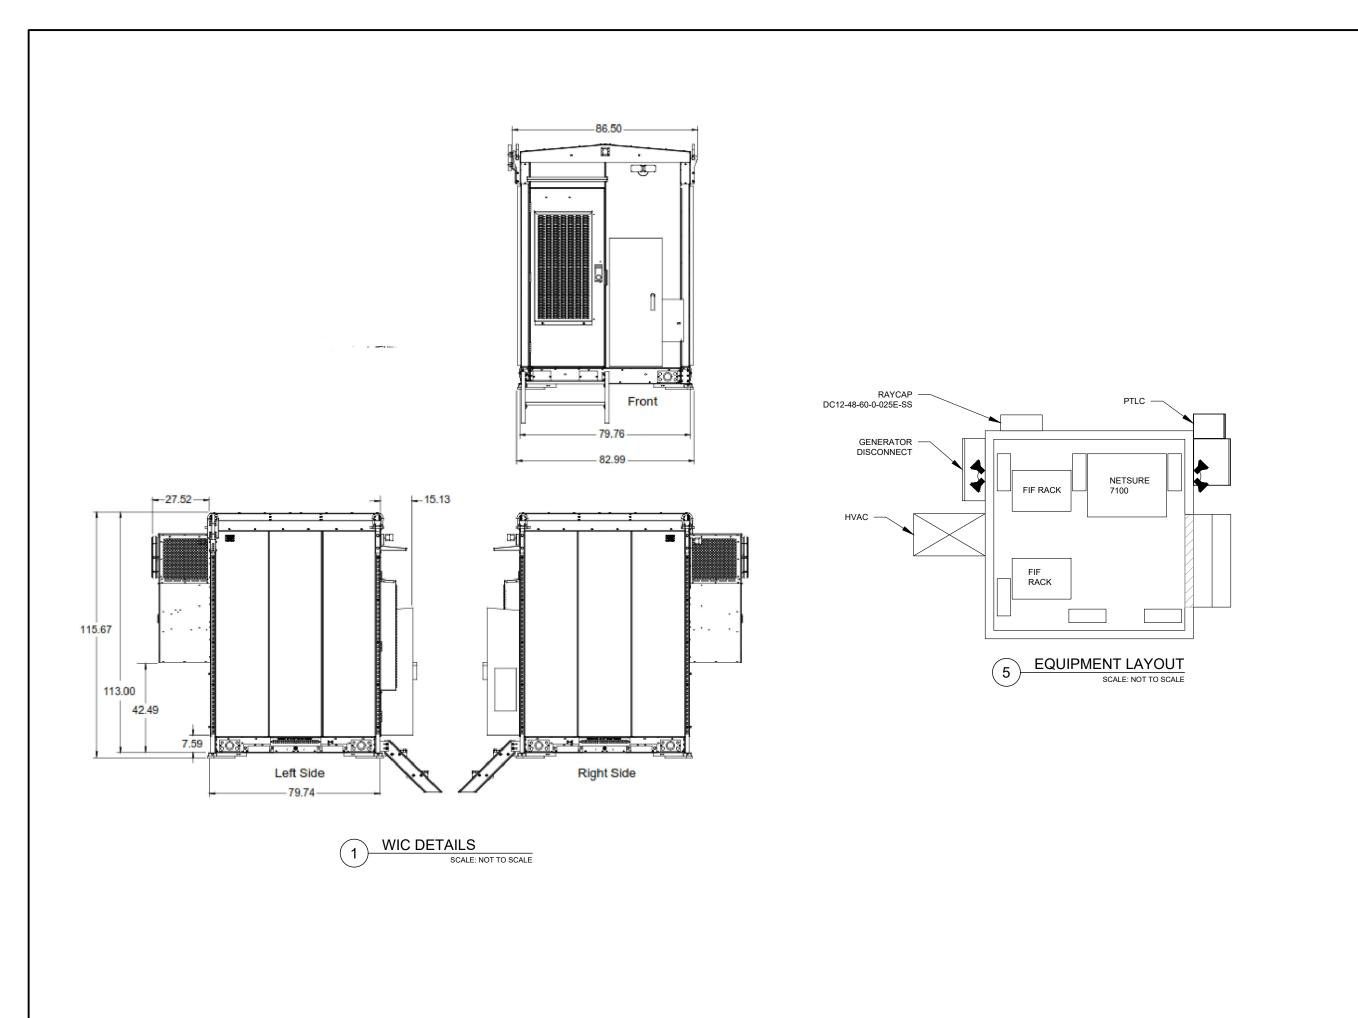

SUPPLEMENTAL SHEET NUMBER: REVISION: R-602

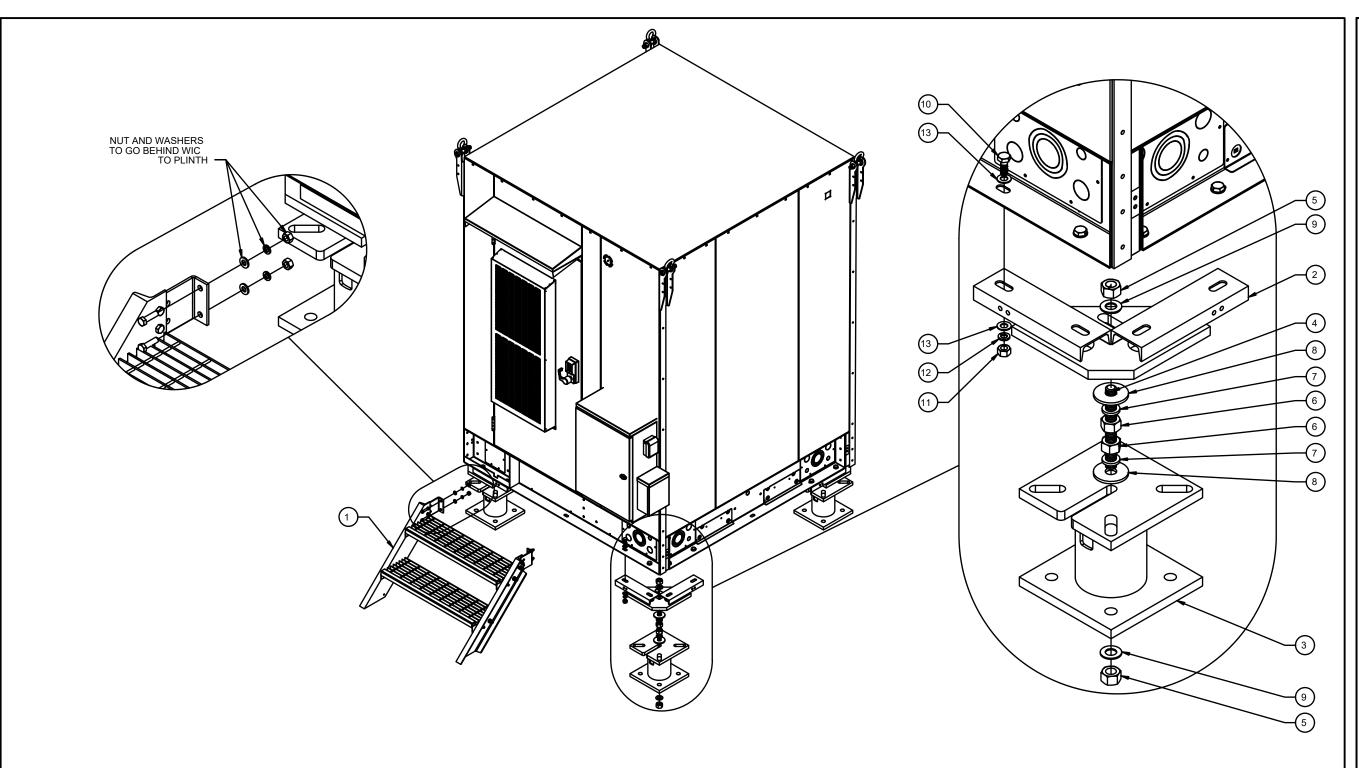

NOTES:

- 1. WIC DETAIL BASED ON DRAWINGS BY VERTIV
- 2. ANCHOR WIC OR PLINTH W/ 1/2" HILTI TZ ANCHORS, EMBEDDED 3-3/4" WITH HILTI HY200 EPOXY ADHESIVE COMPOUND.
- GALVANIZED P1000 TO BE UTILIZED AT WIC FOR DC12, FMB & RRH'S. CAP ENDS & INSTALL PER MANUFACTURER RECOMMENDATIONS.

ITEM NO.	QTY.	PART NUMBER	DESCRIPTION	WEIGHT
1	1	1003-0000-0016	WIC 2-STEP STAIRS KIT, 45 DEGREE	102.9
2	4	W-000-771	ATT WIC HELICAL ADAPTER WELDMENT	44.9
3	4	W-000-847	6" X 11" EXTENSION WELDMENT	81.5
4	4	002-0AT-H000	ROD, THREADED, 1.00"-8 X 9.00" LG, ASTM A193 B7, GALV	1.60
5	8	002-0NG-0000	NUT, HX, ANCO LOCK, 1.00-8UNC, GR 2H, GALV	0.43
6	8	002-0NG-0008	NUT, HX, 1.00"-8UNC, GR 2H, GALV	0.42
7	8	002-0LW-G008	WASHER, SPLIT LOCK, 1.00", GALV	0.09
8	8	002-0FW-G024	WASHER, FLAT, 1.063 ID, 3.25 OD, GALV	0.07
9	8	002-0FW-G009	WASHER, FLAT, 1.00", F436, GALV	0.08
10	16	002-0BG-0033	BOLT, HX HD, .625-11UNC X 1.75" LG, ASTM A325, GALV	0.03
11	16	002-0NG-0011	NUT, HX, .625-11UNC, GR DH, GALV	0.12
12	16	002-0LW-G004	WASHER, SPLIT LOCK, .625 INCH, GALV	0.03
13	32	002-0FW-G004	WASHER, FLAT, .625", ASTM F436, GALV	0.03

SUPPLEMENTAL

SHEET NUMBER:


IUMBER: REVISION:


WIC SHELTER DETAILS


SCALE: NOT TO SCALE


R-603

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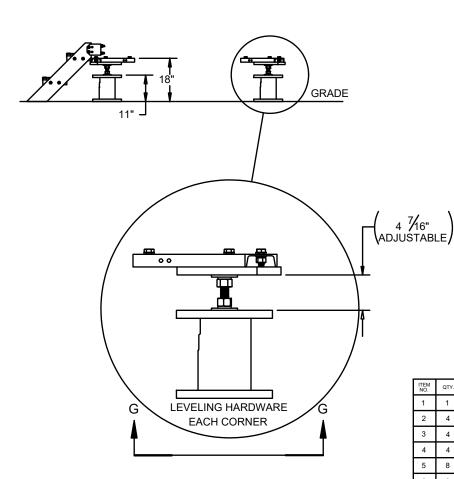


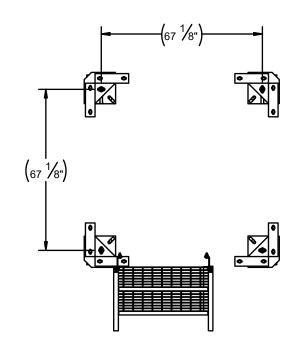

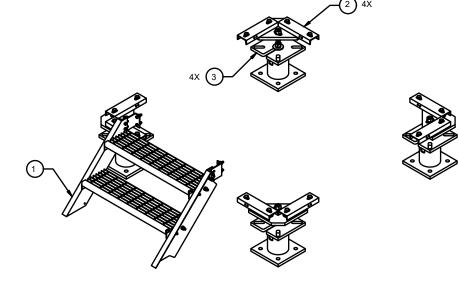

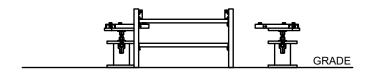

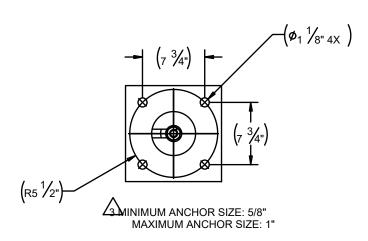CONCRETE ANCHOR LAYOUT SECTION G-G



NOTES:

- 1. WIC DETAIL BASED ON DRAWINGS BY VERTIV
- 2. ANCHOR WIC OR PLINTH W/ 1/2" HILTI TZ ANCHORS, EMBEDDED 3-3/4" WITH HILTI HY200 EPOXY ADHESIVE COMPOUND.
- GALVANIZED P1000 TO BE UTILIZED AT WIC FOR DC12, FMB & RRH'S. CAP ENDS & INSTALL PER MANUFACTURER RECOMMENDATIONS.

NO.	QTY.	PART NUMBER	DESCRIPTION	WEIGHT
1	1	1003-0000-0016	WIC 2-STEP STAIRS KIT, 45 DEGREE	102.9
2	4	W-000-771	ATT WIC HELICAL ADAPTER WELDMENT	44.9
3	4	W-000-847	6" X 11" EXTENSION WELDMENT	81.5
4	4	002-0AT-H000	ROD, THREADED, 1.00"-8 X 9.00" LG, ASTM A193 B7, GALV	1.60
5	8	002-0NG-0000	NUT, HX, ANCO LOCK, 1.00-8UNC, GR 2H, GALV	0.43
6	8	002-0NG-0008	NUT, HX, 1.00"-8UNC, GR 2H, GALV	0.42
7	8	002-0LW-G008	WASHER, SPLIT LOCK, 1.00", GALV	0.09
8	8	002-0FW-G024	WASHER, FLAT, 1.063 ID, 3.25 OD, GALV	0.07
9	8	002-0FW-G009	WASHER, FLAT, 1.00", F436, GALV	0.08
10	16	002-0BG-0033	BOLT, HX HD, .625-11UNC X 1.75" LG, ASTM A325, GALV	0.03
11	16	002-0NG-0011	NUT, HX, .625-11UNC, GR DH, GALV	0.12
12	16	002-0LW-G004	WASHER, SPLIT LOCK, .625 INCH, GALV	0.03
13	32	002-0FW-G004	WASHER, FLAT, .625", ASTM F436, GALV	0.03

SUPPLEMENTAL


SHEET NUMBER:

R-604

REVISION:

1 WIC SHELTER DETAILS

SCALE: NOT TO SCALE

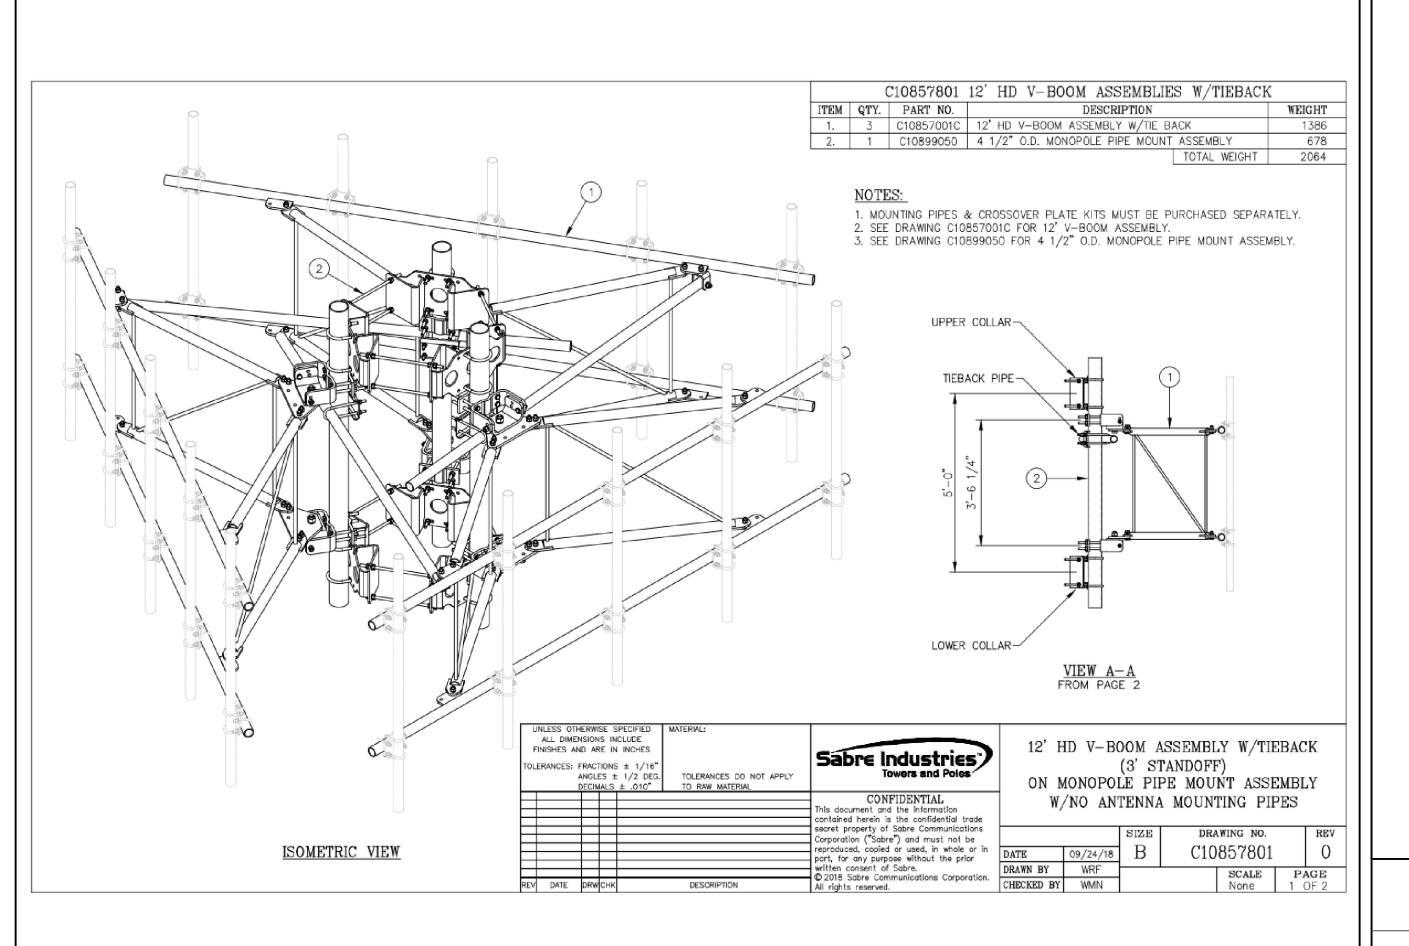


SUPPLEMENTAL

SHEET NUMBER:

REVISION:

R-605

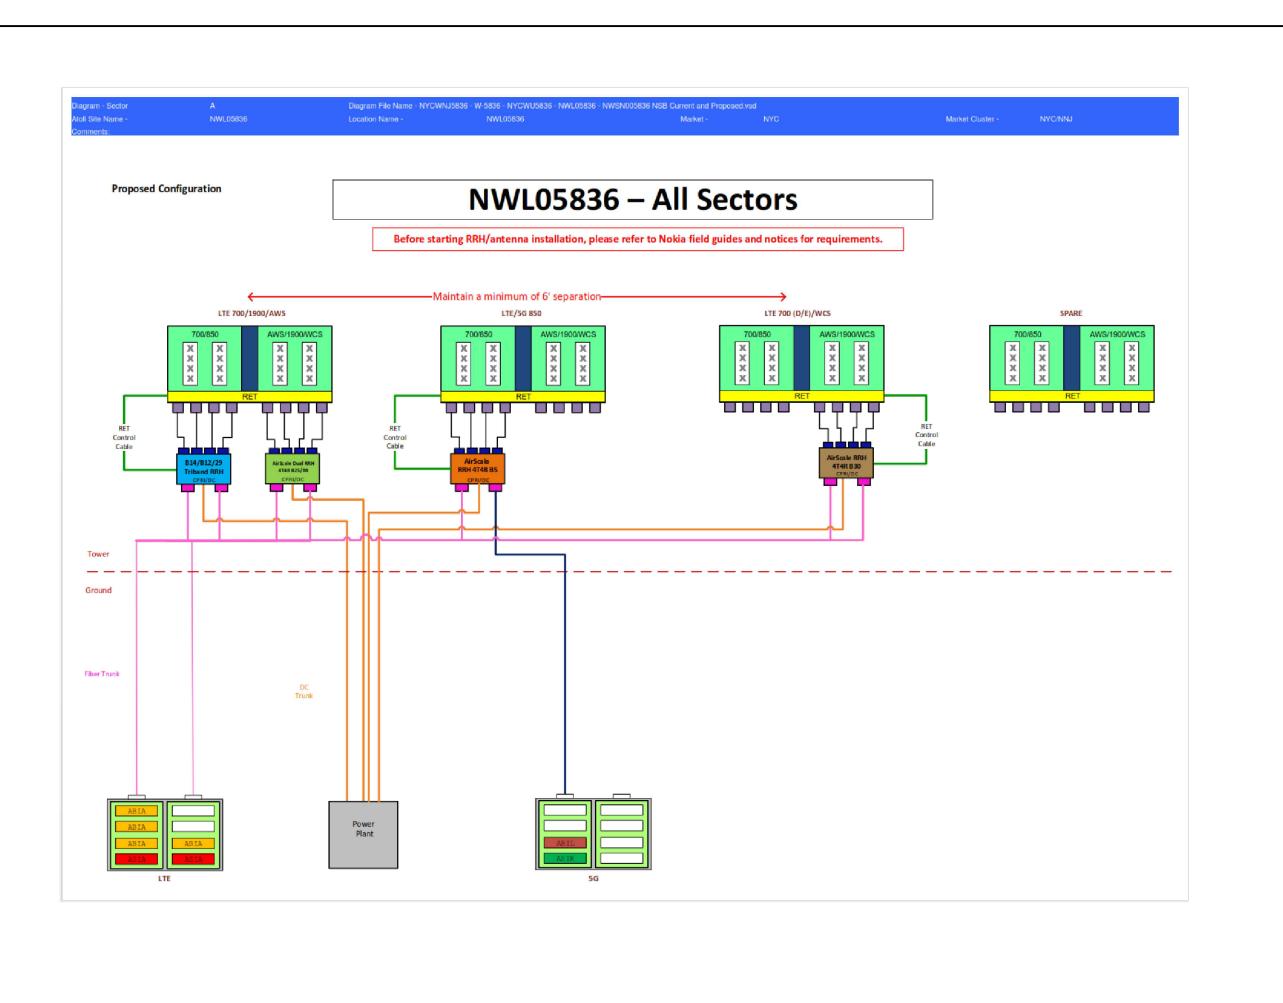

SUPPLEMENTAL

SHEET NUMBER: REVISION:

R-606